CERTIFICATE OF APPROPRIATENESS

Application Date: January 10, 2023
Applicant: Bernardo Rios, architect, Kevin Simmons, owner
Property: 507 E 5th Street tracks 13 & 14 Block 286, Houston Heights. The property includes a 988 SF, one-story wood frame single-family residence on a 5,000SF lot.
Significance: Contributing Craftsman Bungalow, constructed circa 1915, located in the Houston Heights Historic District South.
Proposal: Alteration – Rear Addition – plus detached garage with conditioned space above
Item deferred from March HAHC – significantly revised
2nd story addition to existing house towards rear – adding 595 SF to house
Addition maintains all existing original corners
New Garage with condition space – 850 SF at ground and upper level

• Garage will be attached at 2nd level with unconditioned walkway

Public Comment: No public comment received.

Civic Association: No comment received.

Recommendation: Approval

HAHC Action: -

All materials in exterior walls, including windows, siding, framing lumber, and interior shiplap must be retained except where removal or replacement has been explicitly approved by HAHC. Shiplap is an integral structural component of the exterior wall assembly in balloon framed structures and its removal can cause torqueing, twisting and collapse of exterior walls. Shiplap may be carefully shored and removed in small portions to insulate, run wire or plumbing, and should be replaced when the work is complete. Maintenance and minor in-kind repairs of exterior materials may be undertaken without HAHC approval, but if extensive damage of any exterior wall element is encountered during construction, contact staff before removing or replacing the materials. A revised COA may be required.

CERTIFICATE OF APPROPRIATENESS

Basis for Issuance: Effective:





COA valid for two years from effective date. COA is in addition to any other permits or approvals required by municipal, state and federal law. Permit plans must be stamped by Planning & Development Department for COA compliance prior to submitting for building or sign permits. Any revisions to the approved project scope may require a new COA.

APPROVAL CRITERIA

ALTERATIONS, REHABILITATIONS, RESTORATIONS AND ADDITIONS

Sec. 33-241: HAHC shall issue a certificate of appropriateness for the alteration, rehabilitation, restoration or addition of an exterior feature of (i) any landmark, (ii) protected landmark, (iii) any building, structure or object that is part of an archaeological site, or (iv) contributing building in a historic district upon finding that the application satisfies the following criteria, as applicable:

S	D	NA		S - satisfies D - does not satisfy NA - not applicable
\square			(1)	The proposed activity must retain and preserve the historical character of the property;
\boxtimes			(2)	The proposed activity must contribute to the continued availability of the property for a contemporary use;
			(3)	The proposed activity must recognize the building, structure, object or site as a product of its own time and avoid alterations that seek to create an earlier or later appearance;
			(4)	The proposed activity must preserve the distinguishing qualities or character of the building, structure, object or site and its environment;
			(5)	The proposed activity must maintain or replicate distinctive stylistic exterior features or examples of skilled craftsmanship that characterize the building, structure, object or site;
			(6)	New materials to be used for any exterior feature excluding what is visible from public alleys must be visually compatible with, but not necessarily the same as, the materials being replaced in form, design, texture, dimension and scale;
			(7)	The proposed replacement of missing exterior features, if any, should be based on an accurate duplication of features, substantiated by available historical, physical or pictorial evidence, where that evidence is available, rather than on conjectural designs or the availability of different architectural elements from other structures;
			(8)	Proposed additions or alterations must be done in a manner that, if removed in the future, would leave unimpaired the essential form and integrity of the building, structure, object or site;
			(9)	The proposed design for any exterior alterations or addition must not destroy significant historical, architectural, archaeological or cultural material, including but not limited to siding, windows, doors and porch elements;
			(10)	The proposed alteration or addition must be compatible with the massing, size, scale material and character of the property and the context area; and
			(11)	The distance from the property line to the front and side walls, porches, and exterior features of any proposed addition or alteration must be compatible with the distance to the property line of similar elements of existing contributing structures in the context area.

Houston Archaeological & Historical Commission

March 23, 2023 HP 2023 0006

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HEIGHTS DESIGN GUIDELINES MEASURABLE STANDARDS

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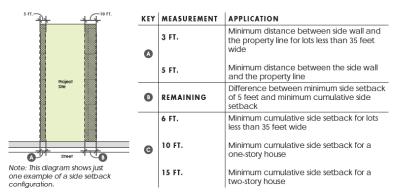
Maximum Lot Coverage (Addition and New Construction)

LOT SIZE	MAXIMUM LOT COVERAGE	
<4000	.44 (44%)	
4000-4999	.44 (44%)	
5000-5999	.42 (42%)	
6000-6999	.40 (40%)	
7000-7999	.38 (38%)	
8000+	.38 (38%)	
	.50 (50%)	

Existing Lot Size: 5,000 SF x .42 = 2,100 SF Proposed Lot Coverage: 1,556 SF Proposed Percentage: .407 rounding up 41% meets

 $\Box \boxtimes \Box$

Side Setbacks (Addition and New Construction)



Proposed side setback (1): 5' – on west Proposed side setback (1): 10' on east

Cumulative side setback: 15' - 15' required - Meets



Maximum Floor Area Ratio (Addition and New Construction)

LOT SIZE	MAXIMUM FAR	
<4000	.48	
4000-4999	.48	
5000-5999	.46	
6000-6999	.44	
7000-7999	.42	
8000+	.40	

Existing Lot Size: 5,000 SF Proposed Sq Ft: 2,300 SF Proposed FAR: 2,227 Meets

FAR Calculations:

FLOOR-TO-AREA RATIO

TOTAL BUILDING AREA	2,227 SF
DETACHED GARAGE EXEMPTION	-528 SF
DETACHED GARAGE APARTMENT EXEMPTION	-528 SF
LEVEL 1	1,135 SF
LEVEL 2	448 SF
DETACHED GARAGE	850 SF
DETACHED GARAGE APARTMENT	850 SF

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Side Wall Length and Insets (Addition and New Construction)

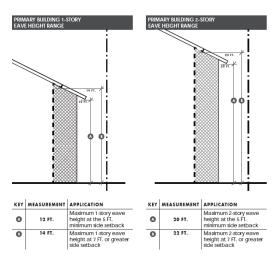
MEASUREMENT APPLICATION

50 FT.	Maximum side wall length without inset (1-story)		
40 FT.	Maximum side wall length without inset (2-story)		
1 FT.	Minimum depth of inset section of side wall (1-story)		
2 FT.	Minimum depth of inset section of side wall (2-story)		
6 FT.	Minimum length of inset section of side wall		

Inset Length: Meets

 $\Box \boxtimes \Box$

Eave Height (Addition and New Construction)



Proposed 2nd floor eave height: 20' 2" Meets

Building Wall (Plate) Height (Addition and New Construction)

MEASUREMENT	APPLICATION

36 IN.	Maximum finished floor height (as measured at the front of the structure)	
10 FT.	Maximum first floor plate height	
9 FT.	Maximum second floor plate height	

Meets

PROPERTY LOCATION



HOUSTON HEIGHTS HISTORIC DISTRICT SOUTH

1 N

Building Classification



5/9/2023

CONTEXT AREA



Figure 2- 448 Columbia St. across street from subject site – non-contributing



Figure 2- 448 Columbia St. directly across the street from the subject site - non-contributing



Figure 3 - Contributing-Context Area East Boundary-House Across Alley from Subject House – 501 Oxford St.



Figure 4 - Another Angle of Context Area Contributing House Across Alley from Subject Property – 501 Oxford St.

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Figure 5 - Context Area View of Boundary Property from Northeast View - 501 Oxford St.



Figure 6 - Context Area - Non-Contributing House to Immediate West of Subject Property – 502 Columbia St

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Figure 7 - South Elevation View Context Area - Subject Property to Right in Image - 502 Columbia



Figure 8 - 2 Contributing Context Houses to the Southwest from Subject Property - 441 & 443 Columbia Respectively

INVENTORY PHOTO



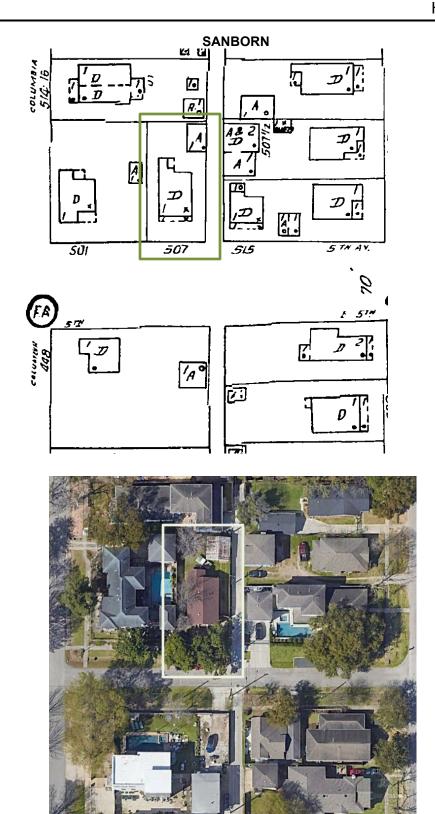
Figure 9 - Above and Below Inventory photos circa 2010 - note undeveloped alley

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 OITY OF HOUSTON | PLANNING & DEVELOPMENT DEPARTMENT | HISTORIC PRESERVATION OFFICE

Houston Archaeological & Historical Commission March 23, 2023

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ITEM D9 507 E 5th Street Houston Heights South



Please see the following drawings for details.

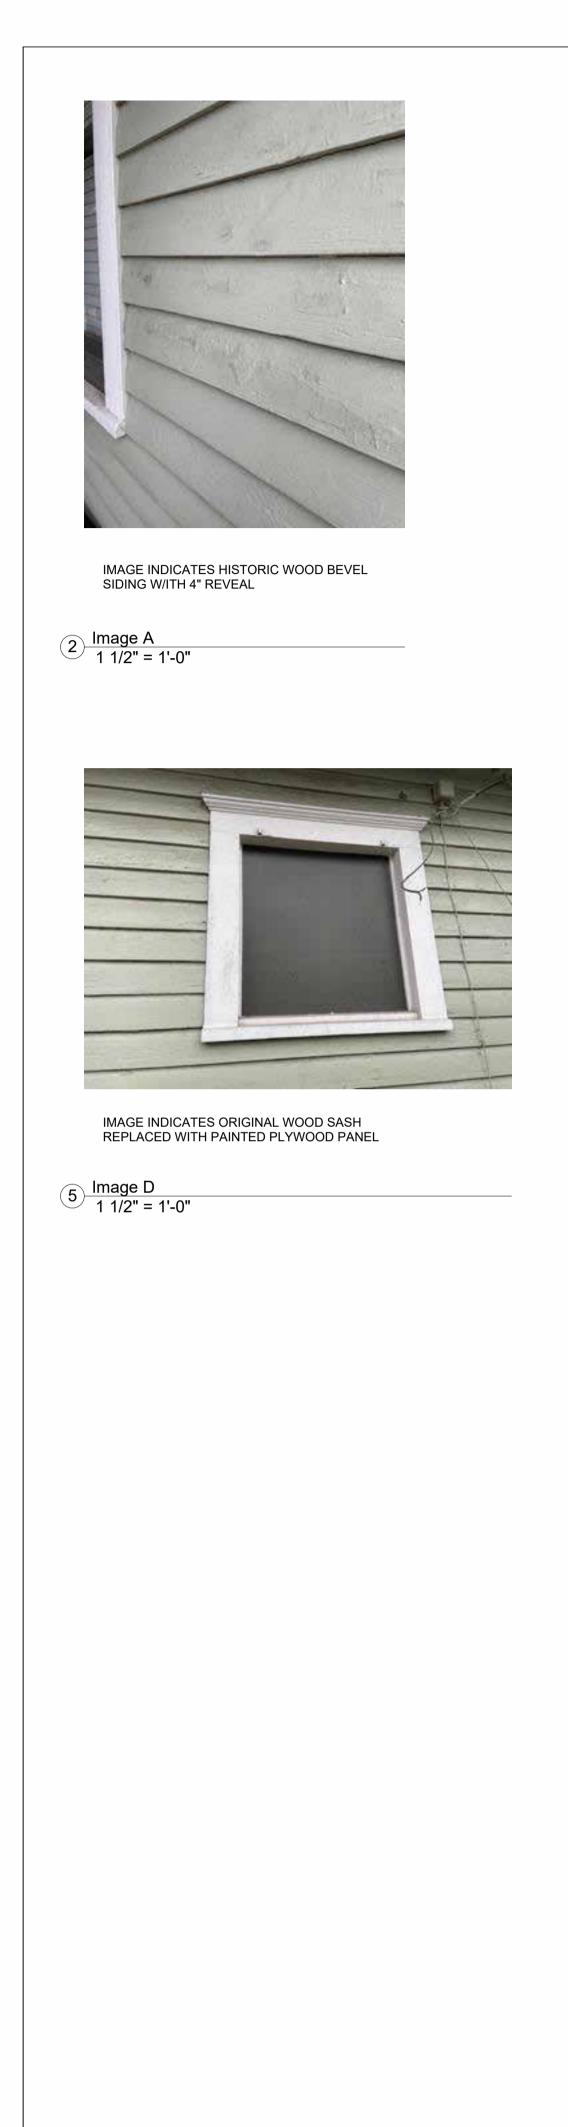




IMAGE INDICATES HISTORIC WOOD BEVEL SIDING W/ITH 4" REVEAL AND 4" TRIM



IMAGE INDICATES STYLE AND CONDITION OF THE MAJORITY OF THE EXISTING WINDOWS

6 Image E 1 1/2" = 1'-0"



IMAGE INDICATES PORTION OF WALL WHERE SIDING HAD BEEN DETERIORATING, TO BE REPLACED WITH SIMILAR NEW SIDING

4 Image C 1 1/2" = 1'-0"



IMAGE INDICATES HISTORIC DETAILING PRESENT: EXPOSED RAFTER TAILS AND CRAFTSMAN GABLE BRACKETS

7 Image F 1 1/2" = 1'-0"

			001
Mark	Width	Height	Material
1.1	2' - 8"	5' - 0"	Wood
1.2	2' - 8"	5' - 0"	Wood
1.3	2' - 8"	5' - 0"	Wood
1.4	2' - 8"		Wood
1.5	3' - 0"		Wood
1.6	2' - 8"	5' - 0"	Wood
1.7		5' - 0"	Wood
1.8	2' - 6"	3' - 10"	Aluminum
1.9	3' - 0"	3' - 0"	Aluminum
1.10	2' - 6"	3' - 10"	Wood
1.11	3' - 0"	2' - 6"	Wood
1.12	2' - 8"	5' - 0"	Wood
1.13	2' - 8"	5' - 0"	Wood
1.14	2' - 8"	5' - 0"	Wood
1.15	2' - 8"	5' - 0"	Wood
1.16	3' - 4"	5' - 0"	Wood
1.17	2' - 8"		Wood
1.18	2' - 8"		Wood
1.19		4' - 0"	Wood
1.20	2' - 0"	4' - 0"	Wood
1.21		4' - 0"	Wood
1.22	2' - 0"	4' - 0"	Wood
1.23	2' - 0"	4' - 0"	Wood
1.24	2' - 0"	4' - 0"	Wood
1.25	3' - 0"	3' - 0"	Wood
1.26	3' - 0"	3' - 0"	Wood
1.27	3' - 0"	3' - 0"	Wood
1.28	3' - 0"	3' - 0"	Wood
2.1	3' - 0"	3' - 0"	Wood
2.2	3' - 0"	3' - 0"	Wood
2.3	3' - 0"	3' - 0"	Wood
2.4	3' - 0"	3' - 0"	Wood
2.5	3' - 0"	3' - 0"	Wood
2.6	3' - 0"	3' - 0"	Wood
2.7	3' - 0"	3' - 0"	Wood
2.8	3' - 0"	3' - 0"	Wood
2.9	3' - 0"	3' - 0"	Wood
2.10	3' - 0"	3' - 0"	Wood
2.11	3' - 0"	3' - 0"	Wood
2.12	3' - 0"	3' - 0"	Wood
2.12	3' - 0"	3' - 0"	Wood
2.14	2' - 8"	2' - 8"	Wood
2.15	2' - 0"	2' - 0"	Wood
2.16	3' - 0"	2 - 0" 3' - 0"	Wood
2.10	3' - 0"	3' - 0"	Wood
2.17	3' - 0"	3' - 0"	Wood
2.10	3' - 0"	3' - 0"	Wood
2.10	5 0		

MEASUREABLE STANDARDS		
LOT SIZE: MAXIMUM LOT COVERAGE ALLOWED: FLOOR-TO-AREA RATIO (FAR)	42% 46%	5,000 SF 2,100 SF 2,300 SF
MAXIMUM LOT COVERAGE CALCS.		
HOUSE GROUND FLOOR AREA DETACHED GARAGE		1,174 SF 910 SF
DETACHED GARAGE EXEMPTION		-528 SF
TOTAL LOT COVERAGE		1,556 SF
TOTAL LOT COVERAGE		1,556 SF
TOTAL LOT COVERAGE		1,556 SF
		1,556 SF 1,135 SF 448 SF 850 SF 850 SF
FLOOR-TO-AREA RATIO LEVEL 1 LEVEL 2 DETACHED GARAGE	DN	1,135 SF 448 SF 850 SF

9 Measurable Standards by Floor 1 1/2" = 1'-0"

8 3D View 1

507 E. 5th St. - Window Schedule Comments Family

Existing To Remain

Window-Double-Hung Window-Double-Hung Window-Double-Hung Window-Double-Hung Fixed with Trim Window-Double-Hung Window-Double-Hung Window-Double-Hung Window-Double-Hung Window-Double-Hung Fixed with Trim Window-Double-Hung Window-Double-Hung Window-Double-Hung Window-Double-Hung Window-Double-Hung Window-Double-Hung Window-Double-Hung Fixed with Trim Fixed with Trim

Existing to Remain
Existing To Remain
Existing To Remain
Existing To Remain
Original Wood Window Frame / Missing Sash / Plywood Infill
Existing To Be Replaced w/ New Jeld-Wen Window
Existing To Be Replaced w/ New Jeld-Wen Window
Original Wood Window Frame / Non-original Aluminum Sash -
To Be Removed
Non-Original Aluminum Window and Frame - To Be Removed
Existing To Remain - To Be Removed
Existing To Remain
Proposed New Jeld-Wen Wood Window



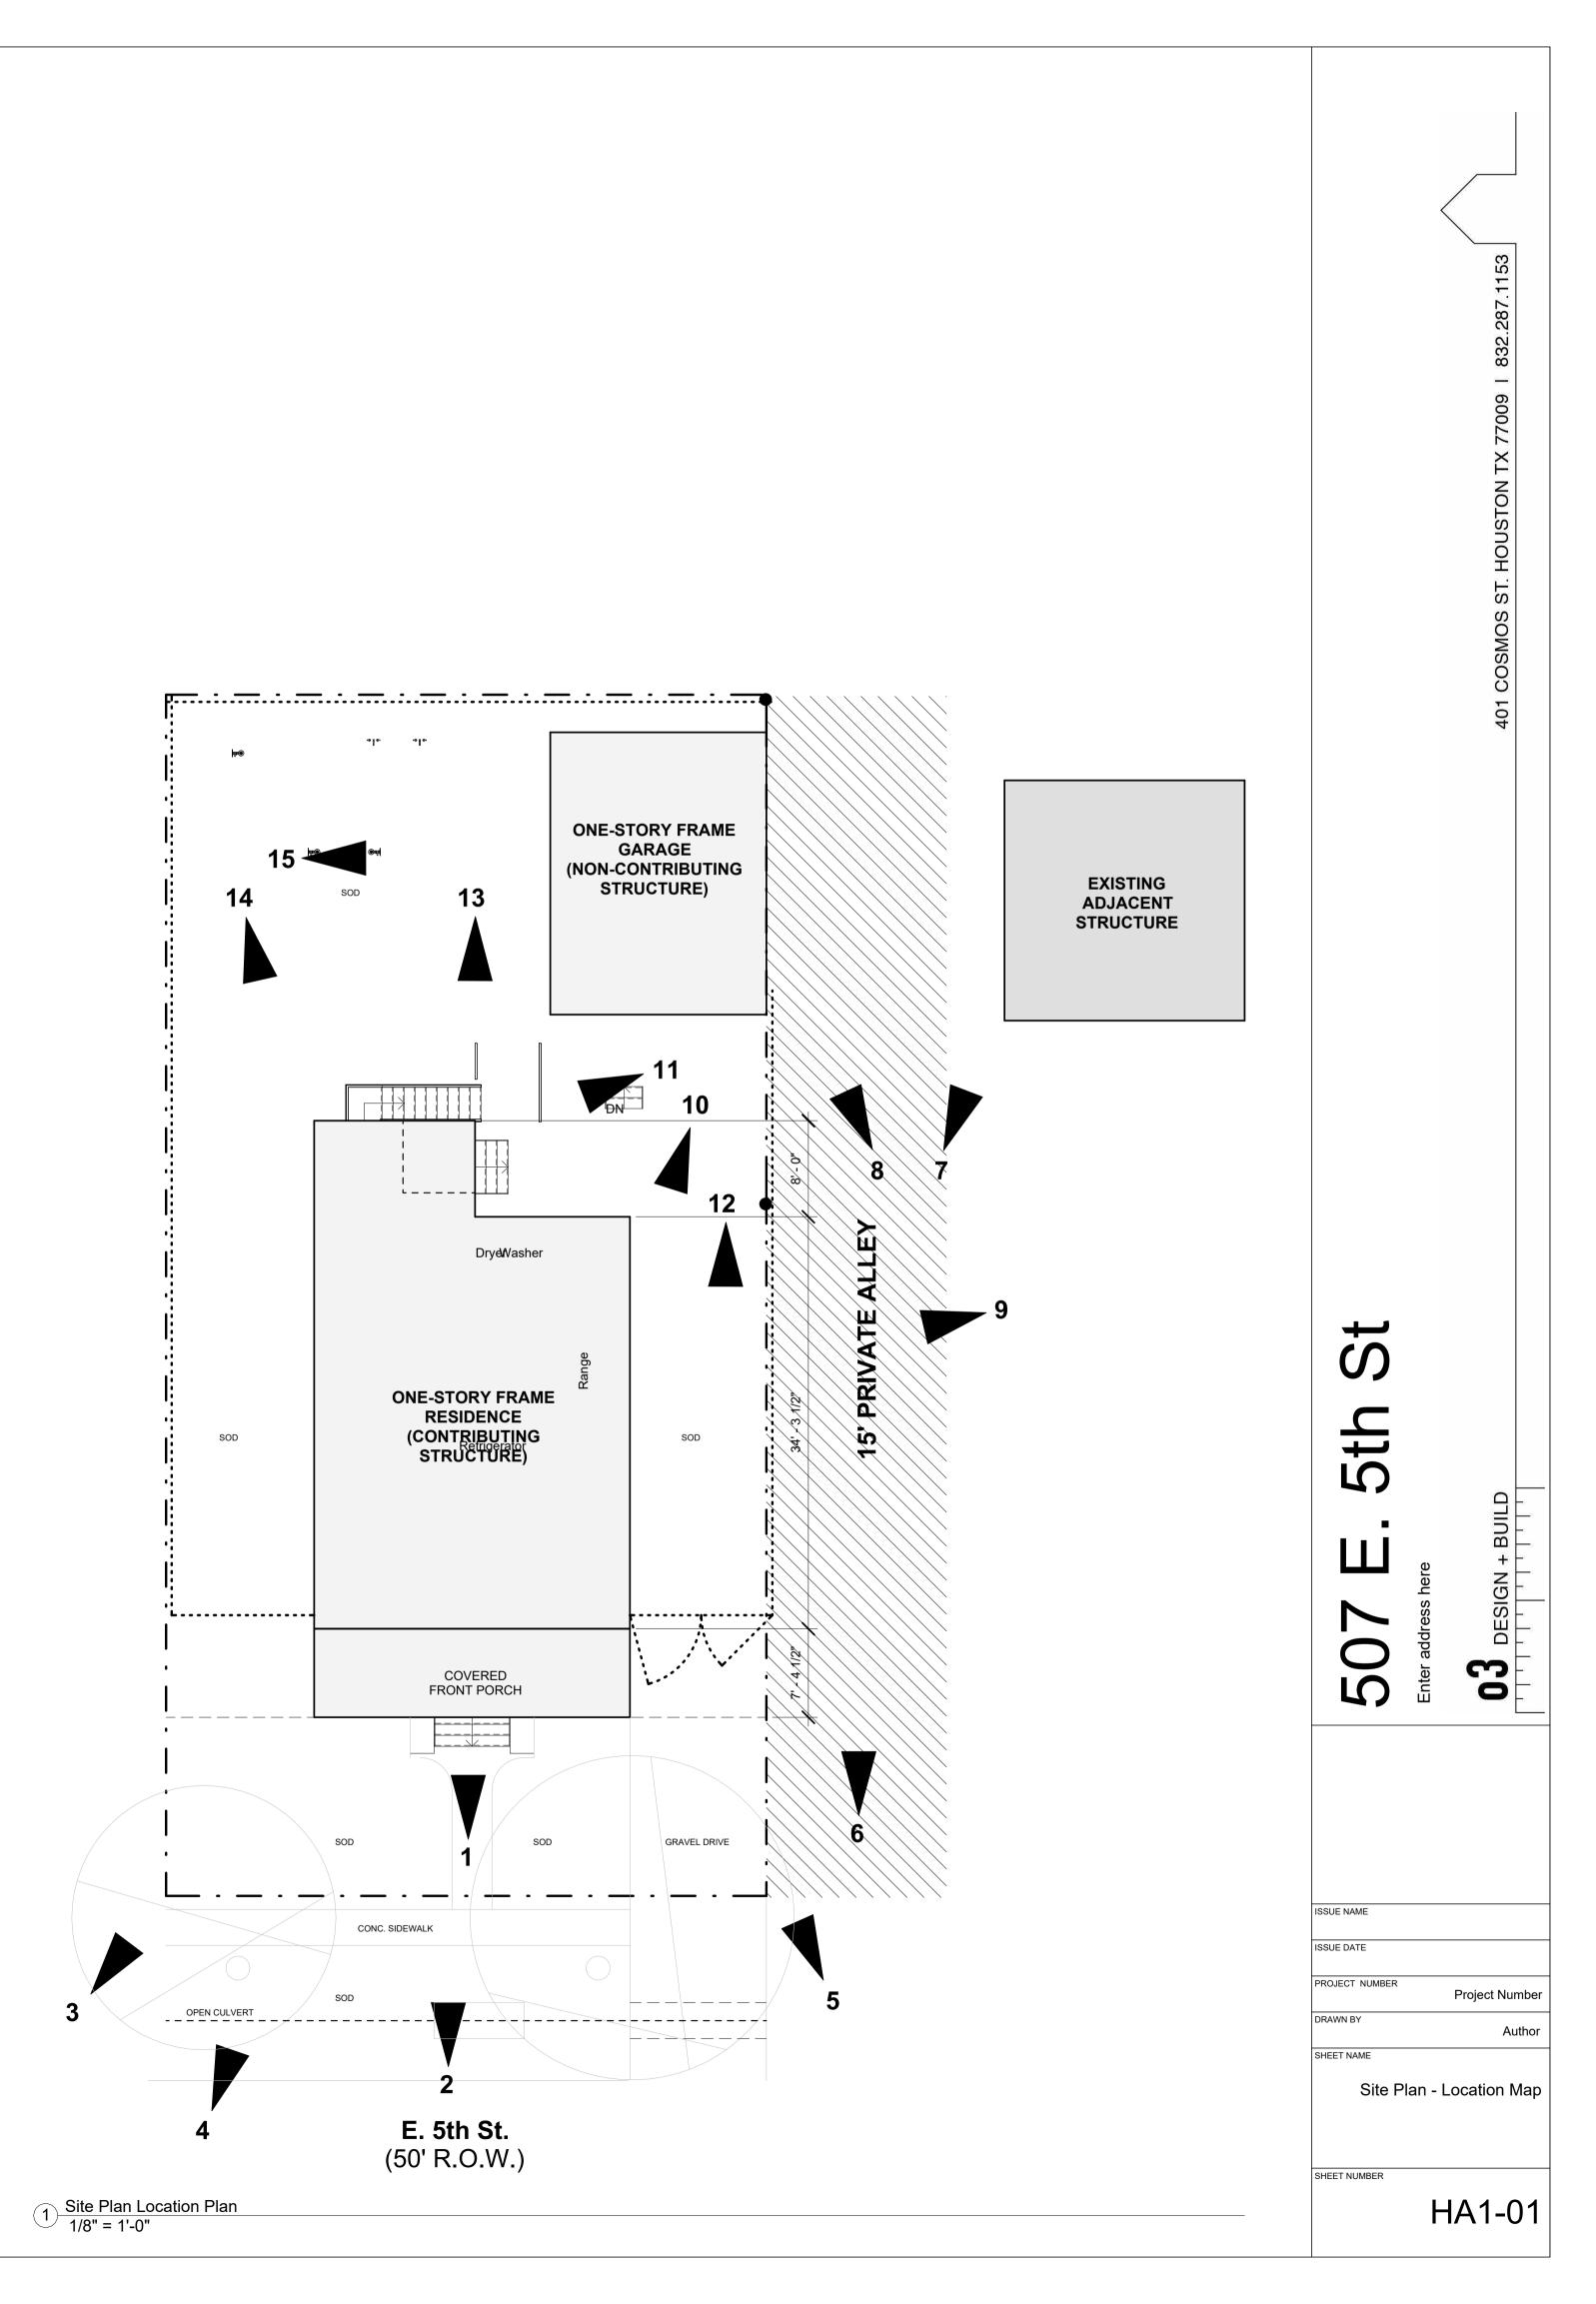
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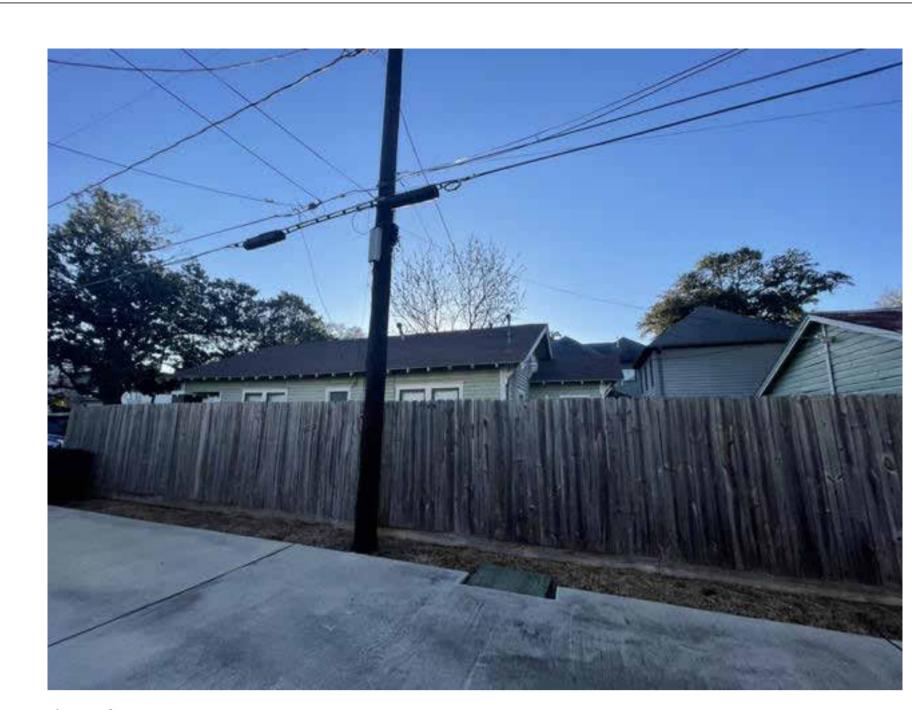
Project Information

SHEET NAME

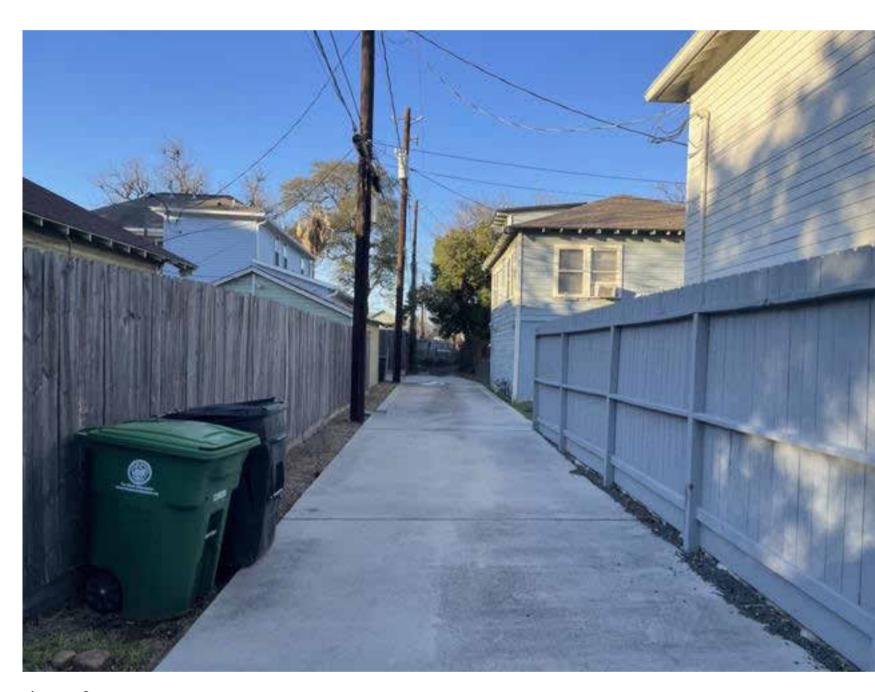
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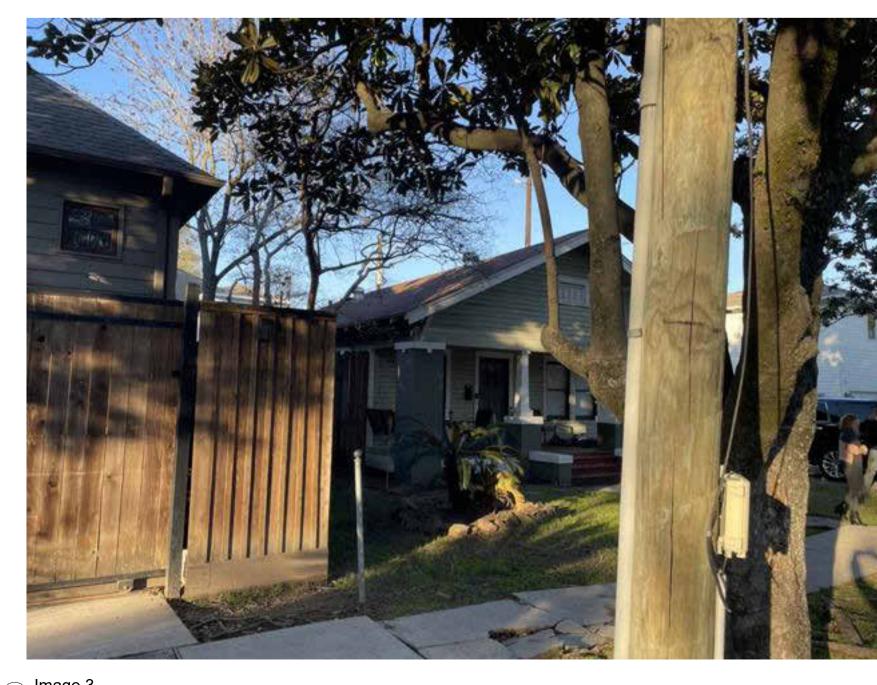




9 Image 9 1 1/2" = 1'-0"



6 Image 6 1 1/2" = 1'-0"



3 Image 3 1 1/2" = 1'-0"



8 Image 8 1 1/2" = 1'-0"

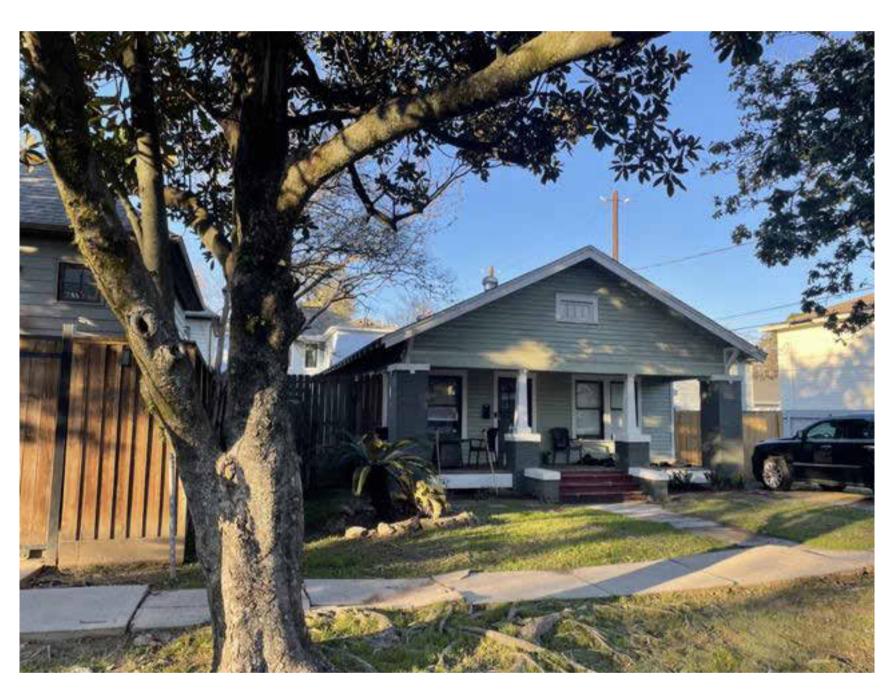


5 Image 5 1 1/2" = 1'-0"

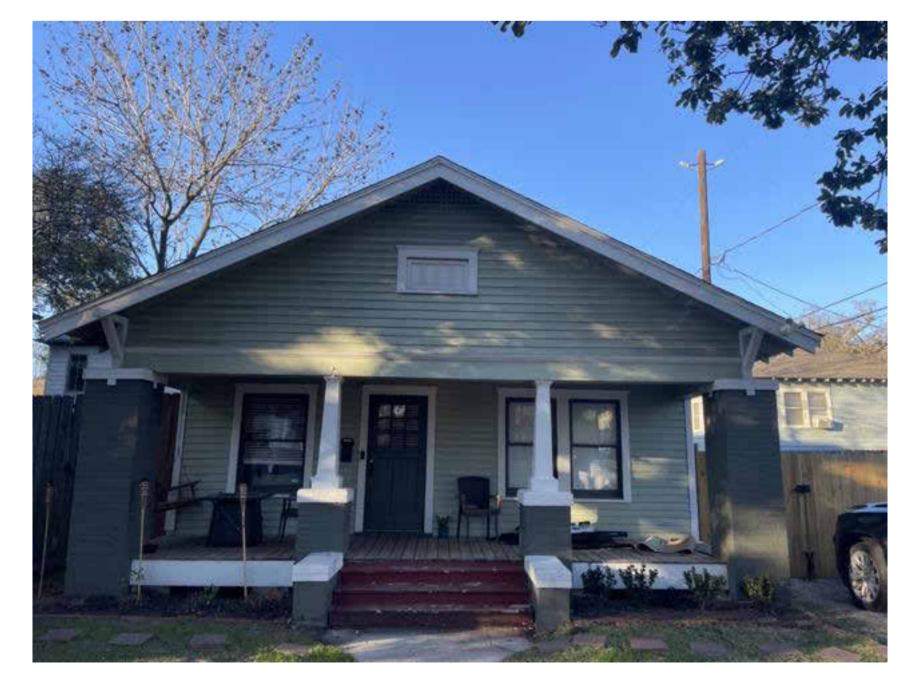




7 Image 7 1 1/2" = 1'-0"



4 Image 4 1 1/2" = 1'-0"



1 lmage 1 1 1/2" = 1'-0"

2 Image 2 1 1/2" = 1'-0"

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507 E. 5th St	Enter address here	03 DESIGN + BUILD
ISSUE NAME ISSUE DATE PROJECT NUMBER DRAWN BY SHEET NAME SHEET NUMBER		Project Number Author Site Images



6 Image 15 1 1/2" = 1'-0"



3 Image 12 1 1/2" = 1'-0"



5 Image 14 1 1/2" = 1'-0"

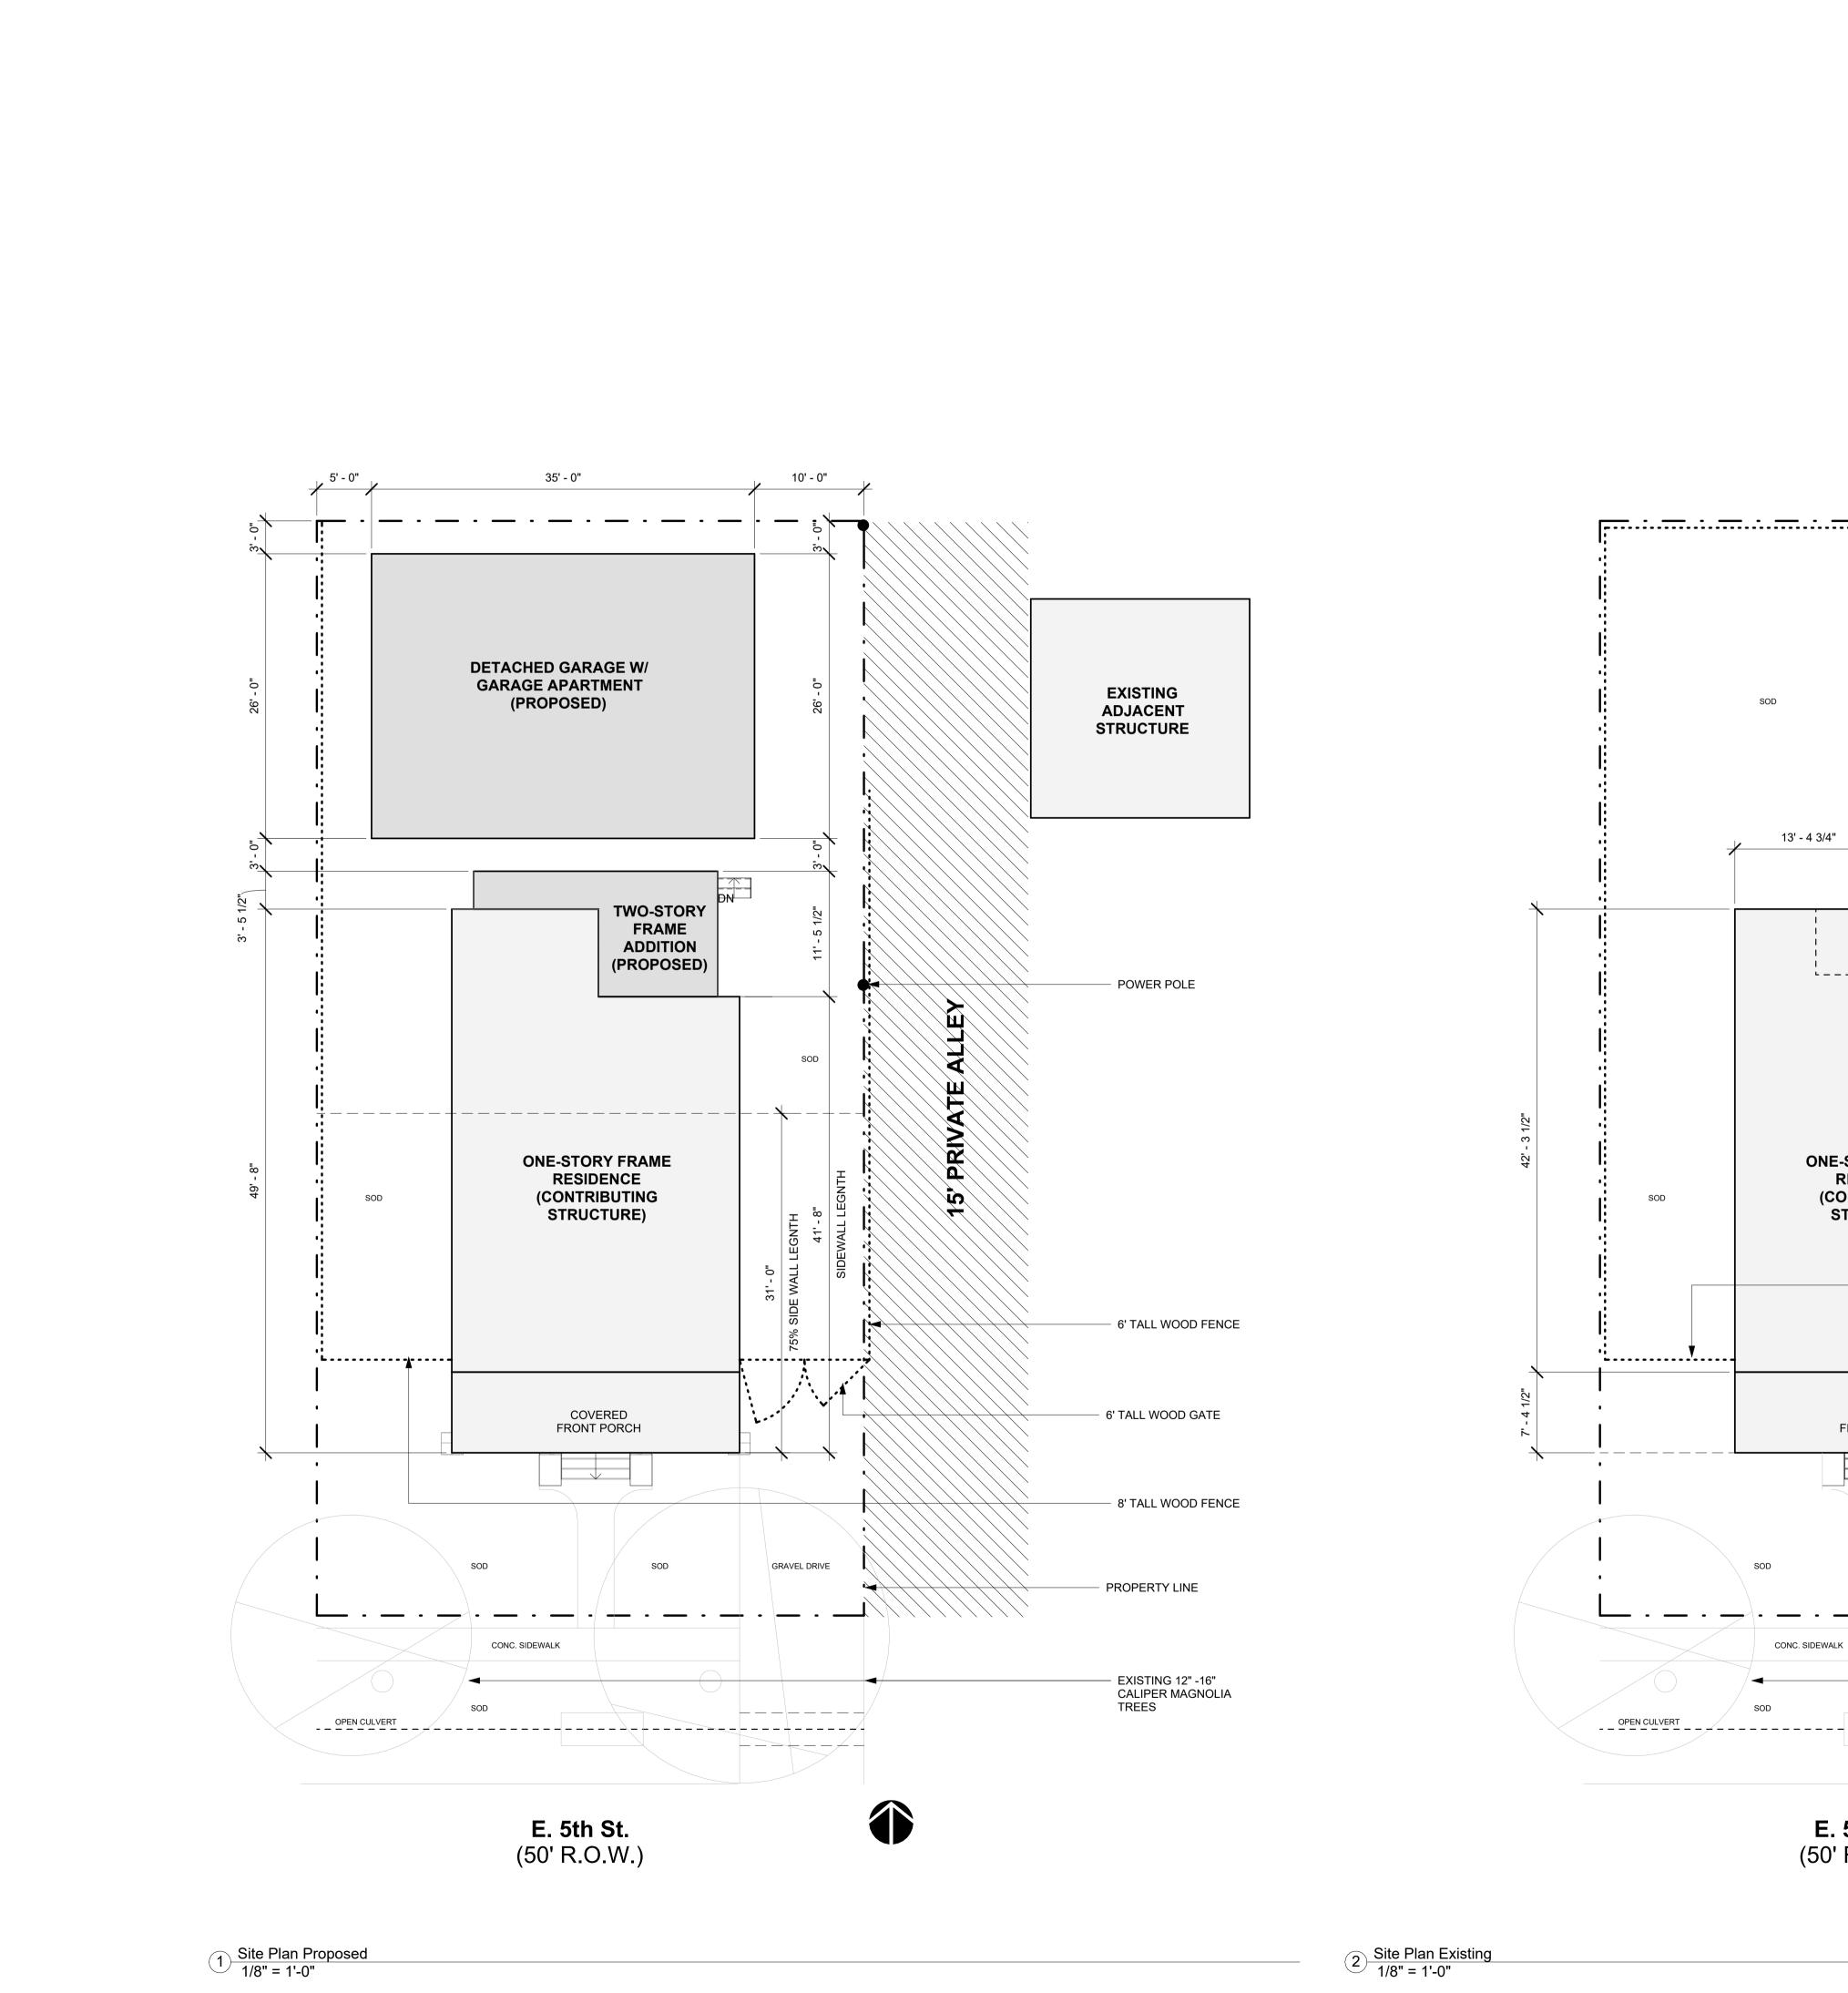






1 Image 10 1 1/2" = 1'-0"

2 Image 11 1 1/2" = 1'-0"

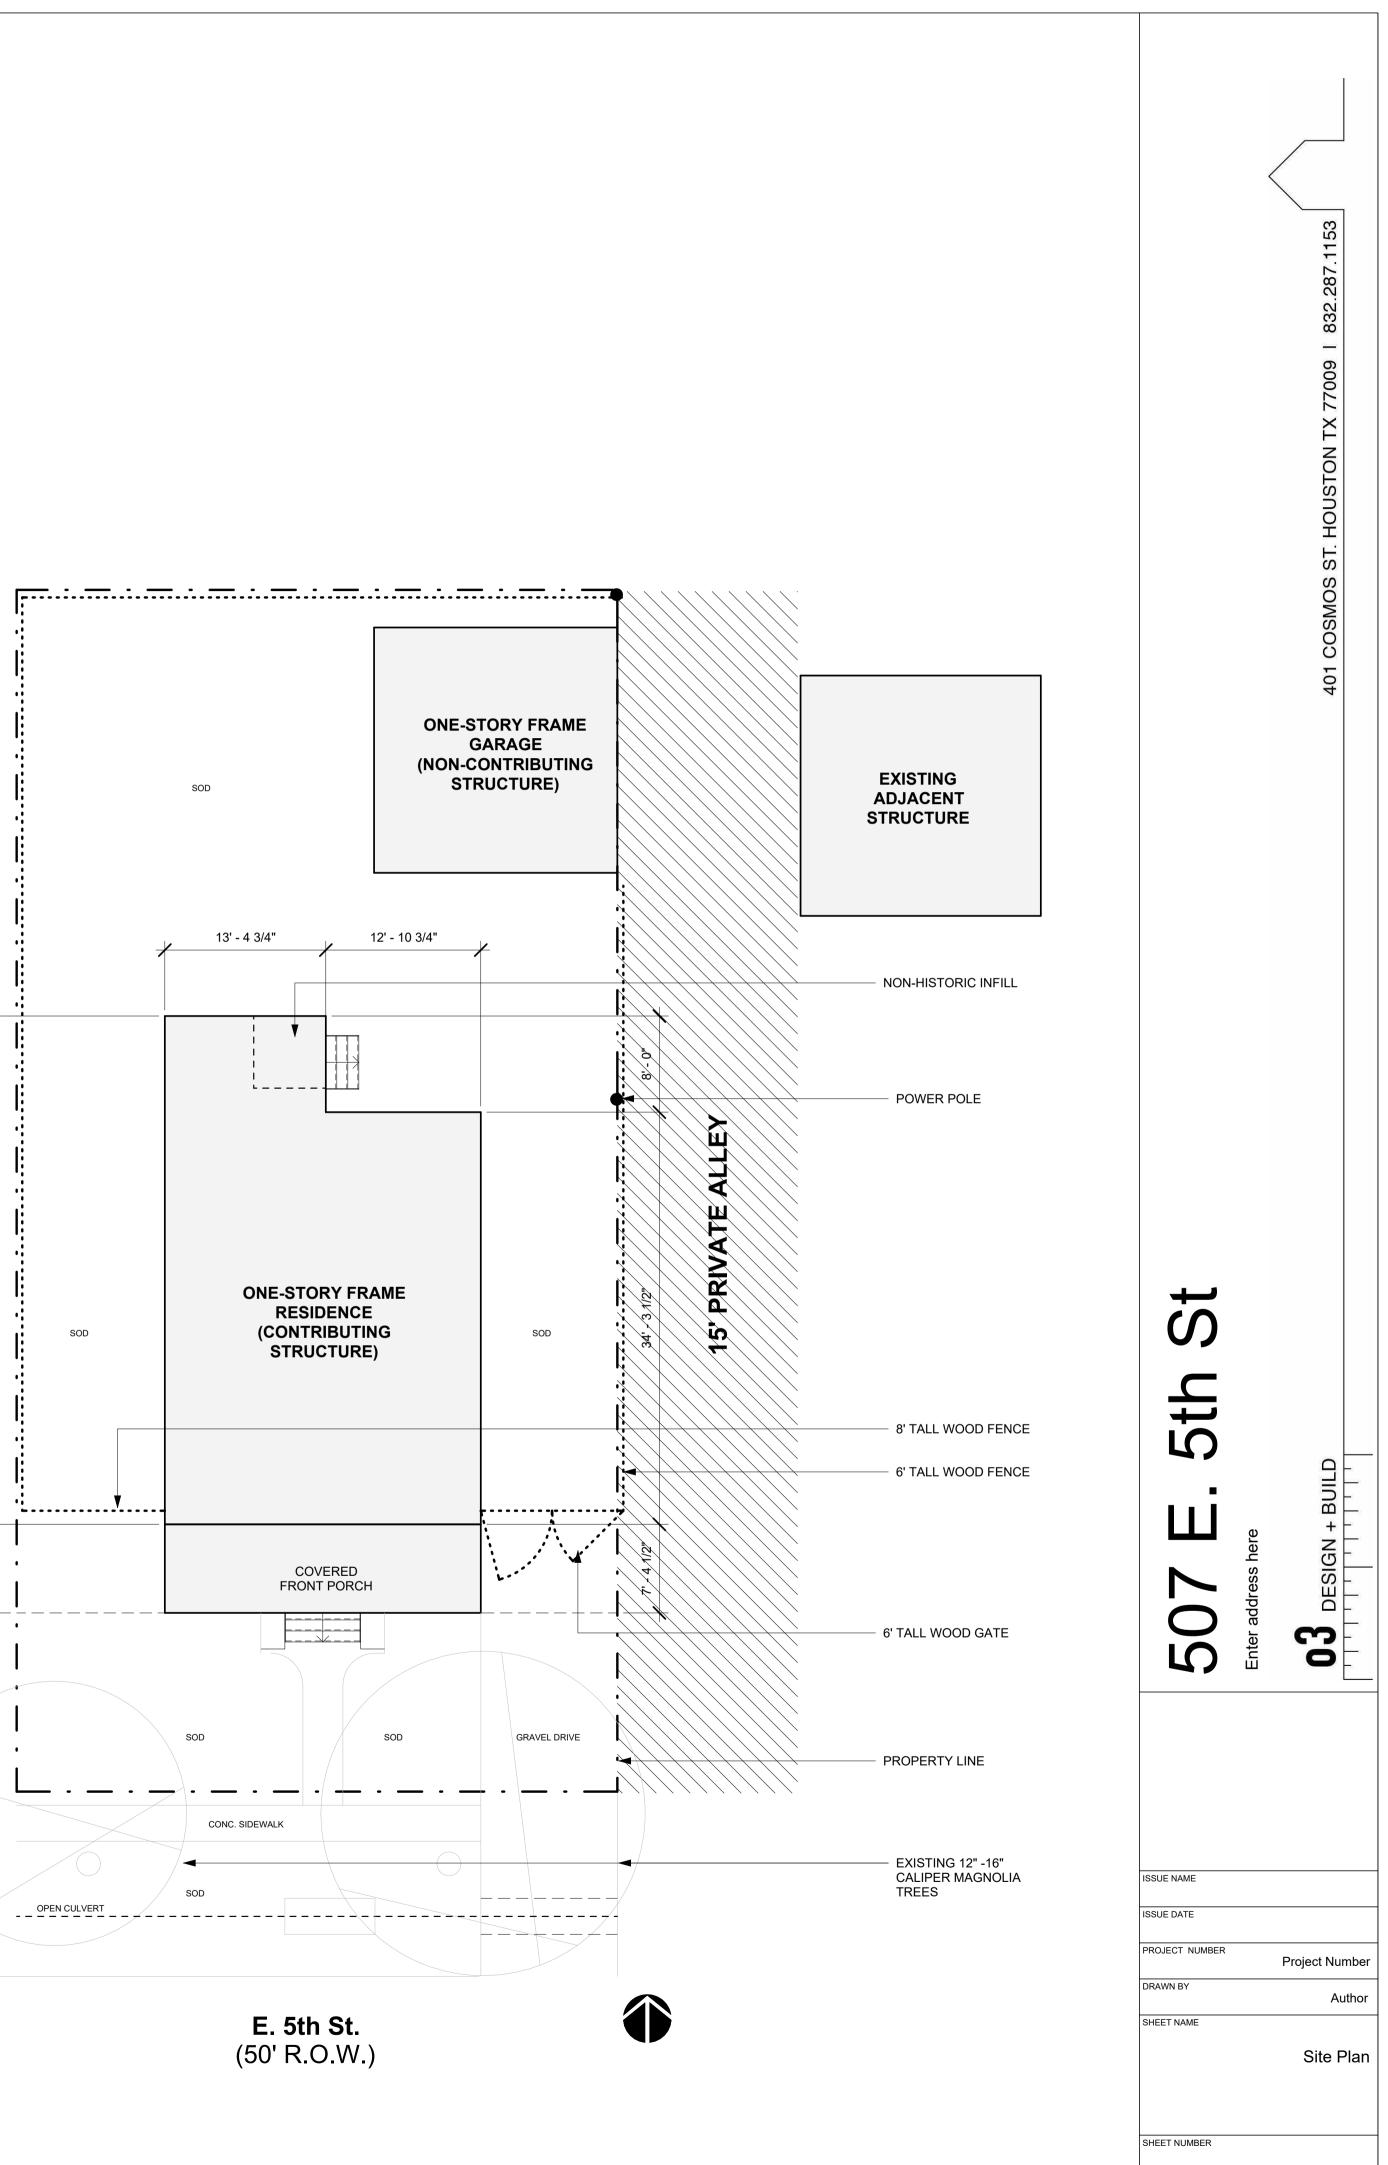


E. 5th St. (50' R.O.W.)

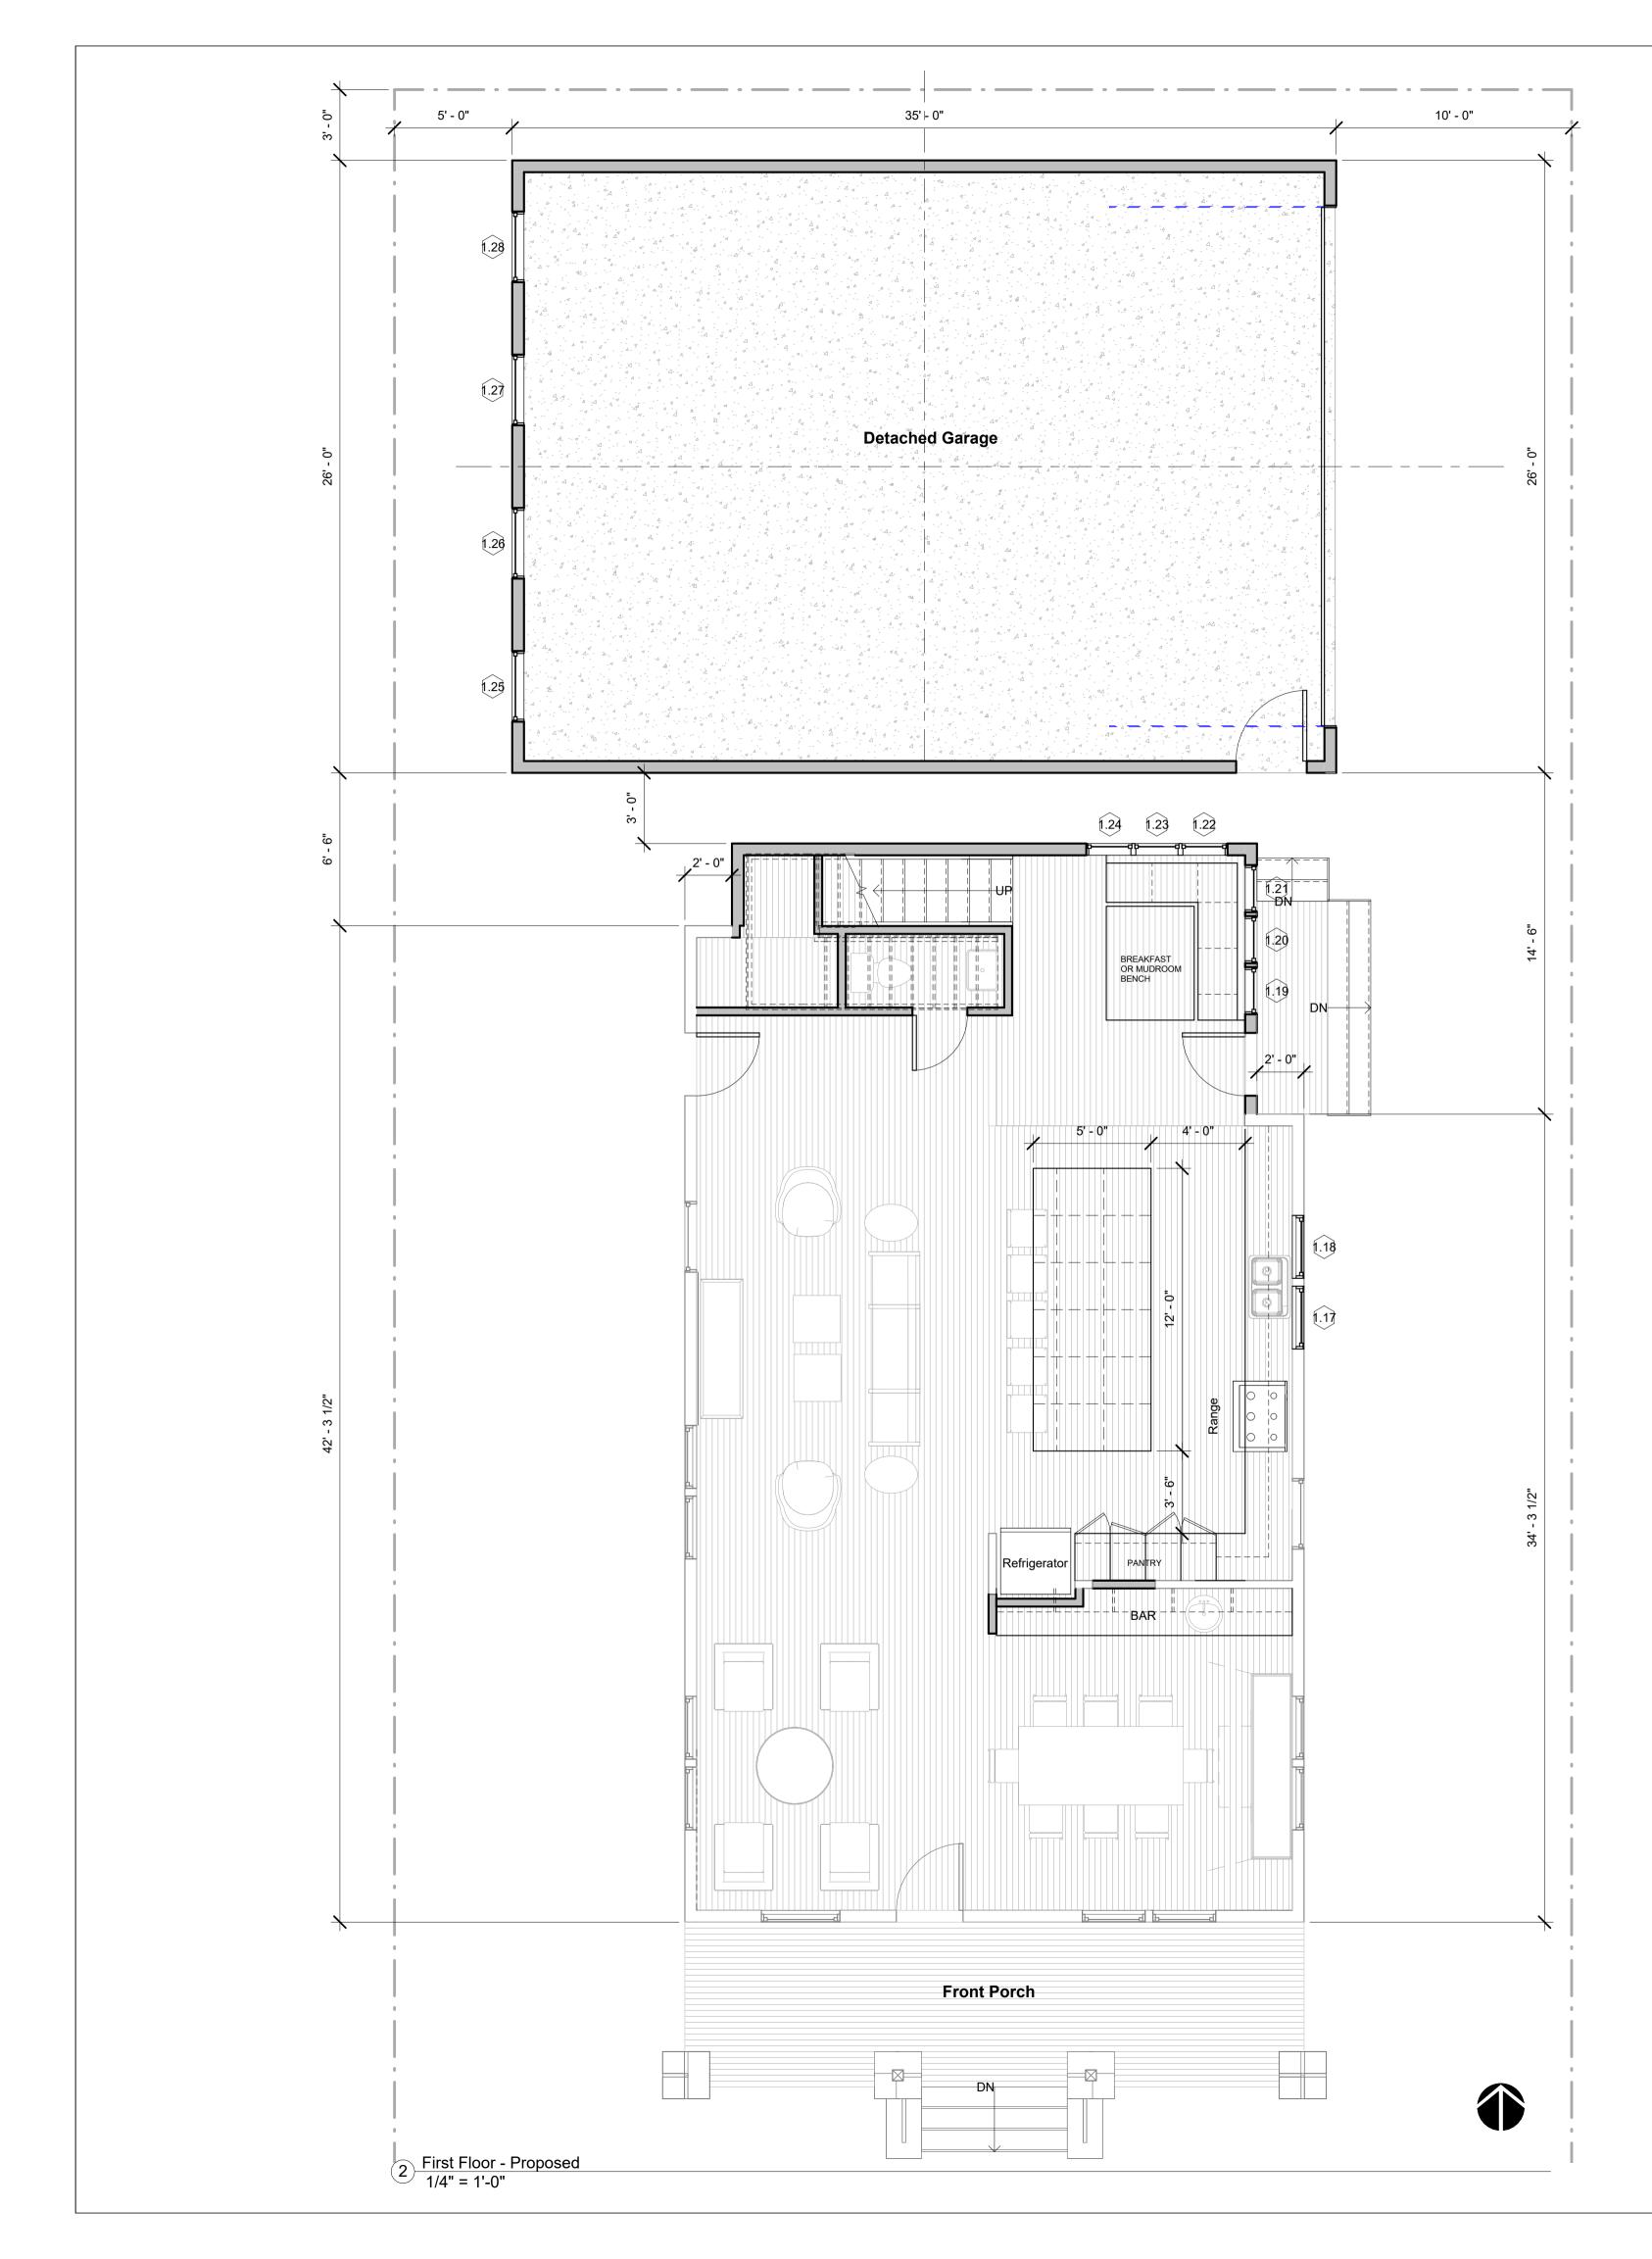
13' - 4 3/4"

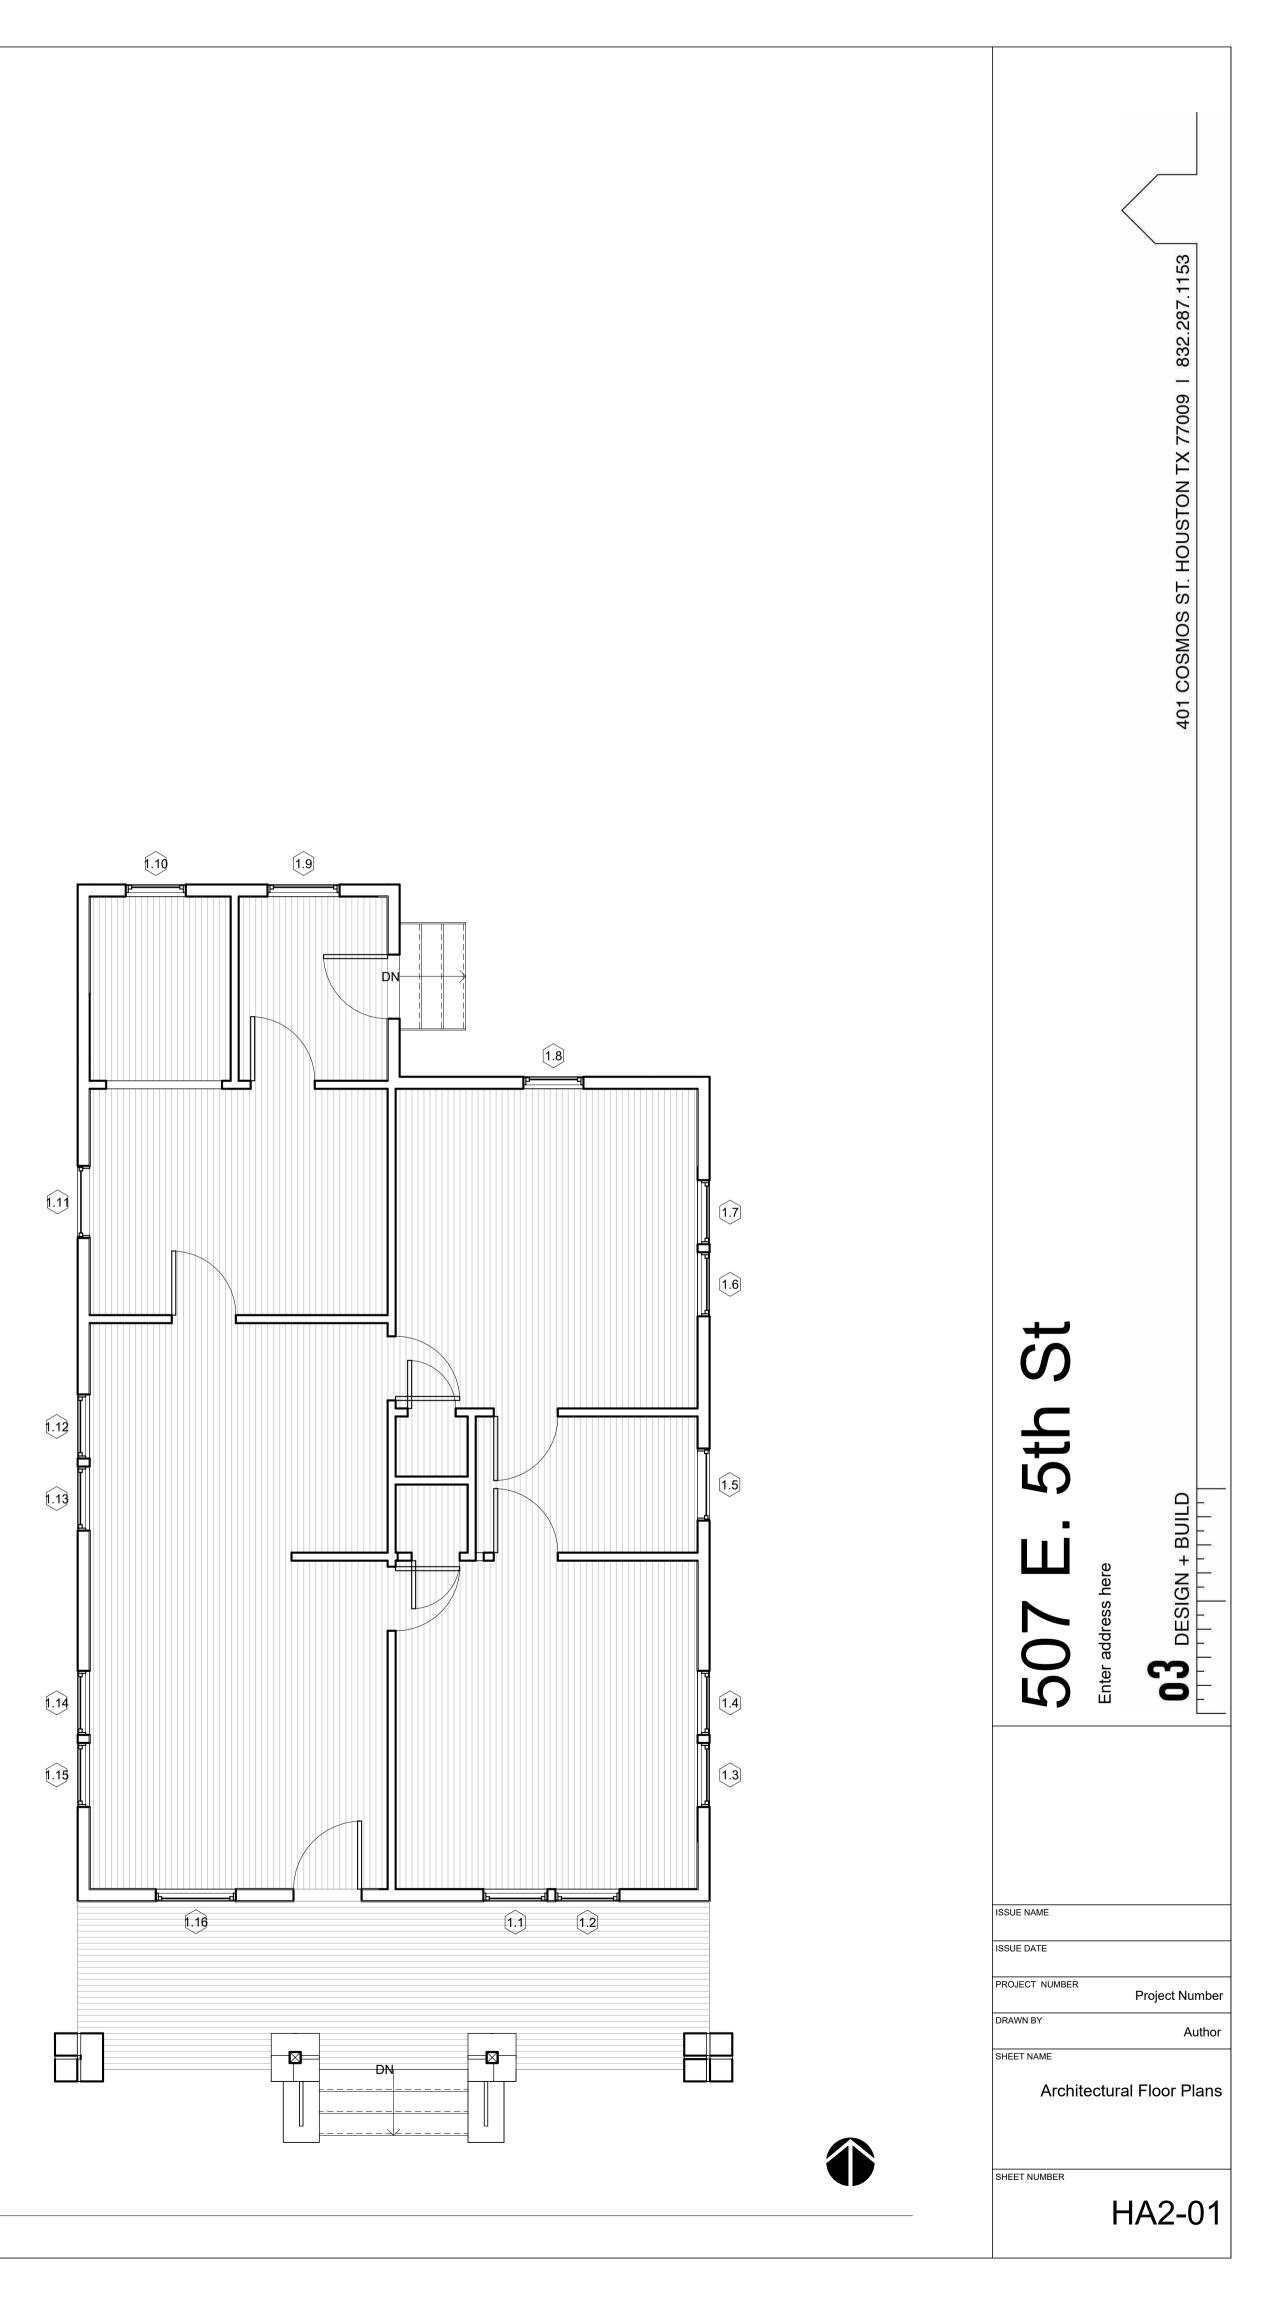
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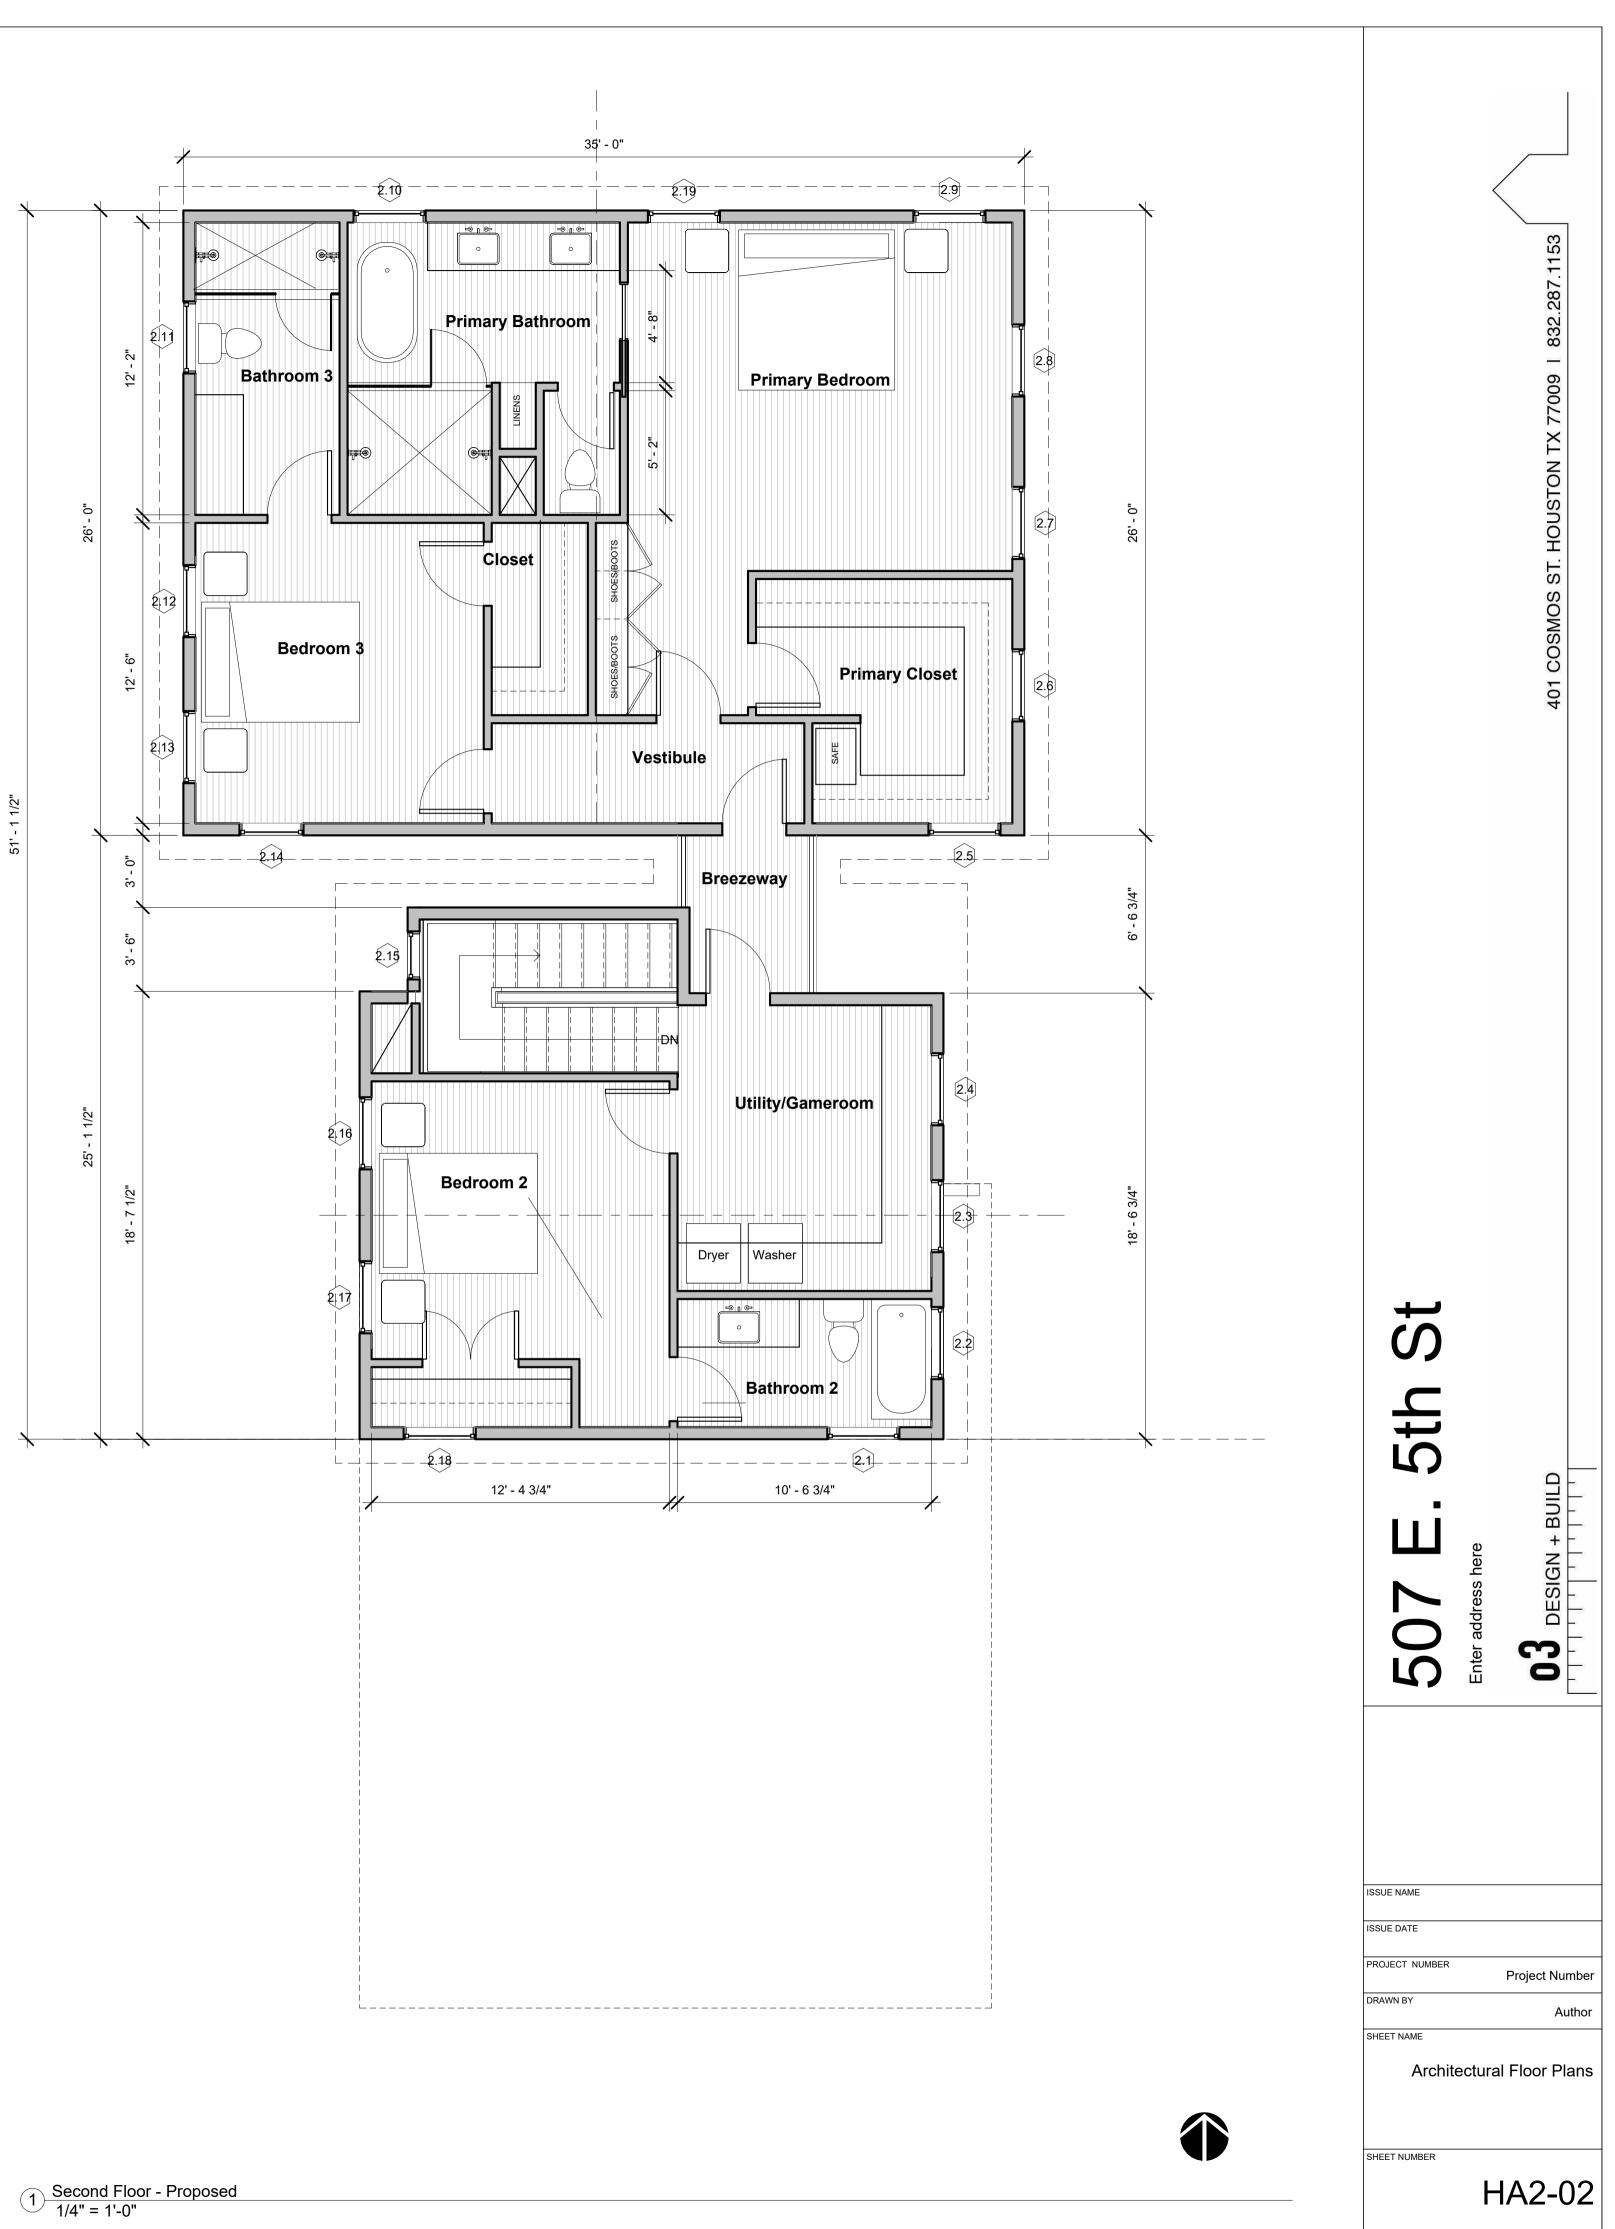


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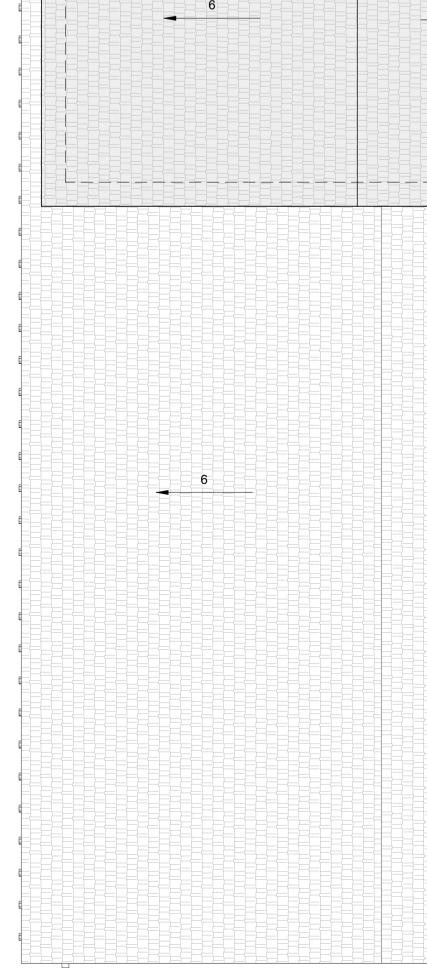






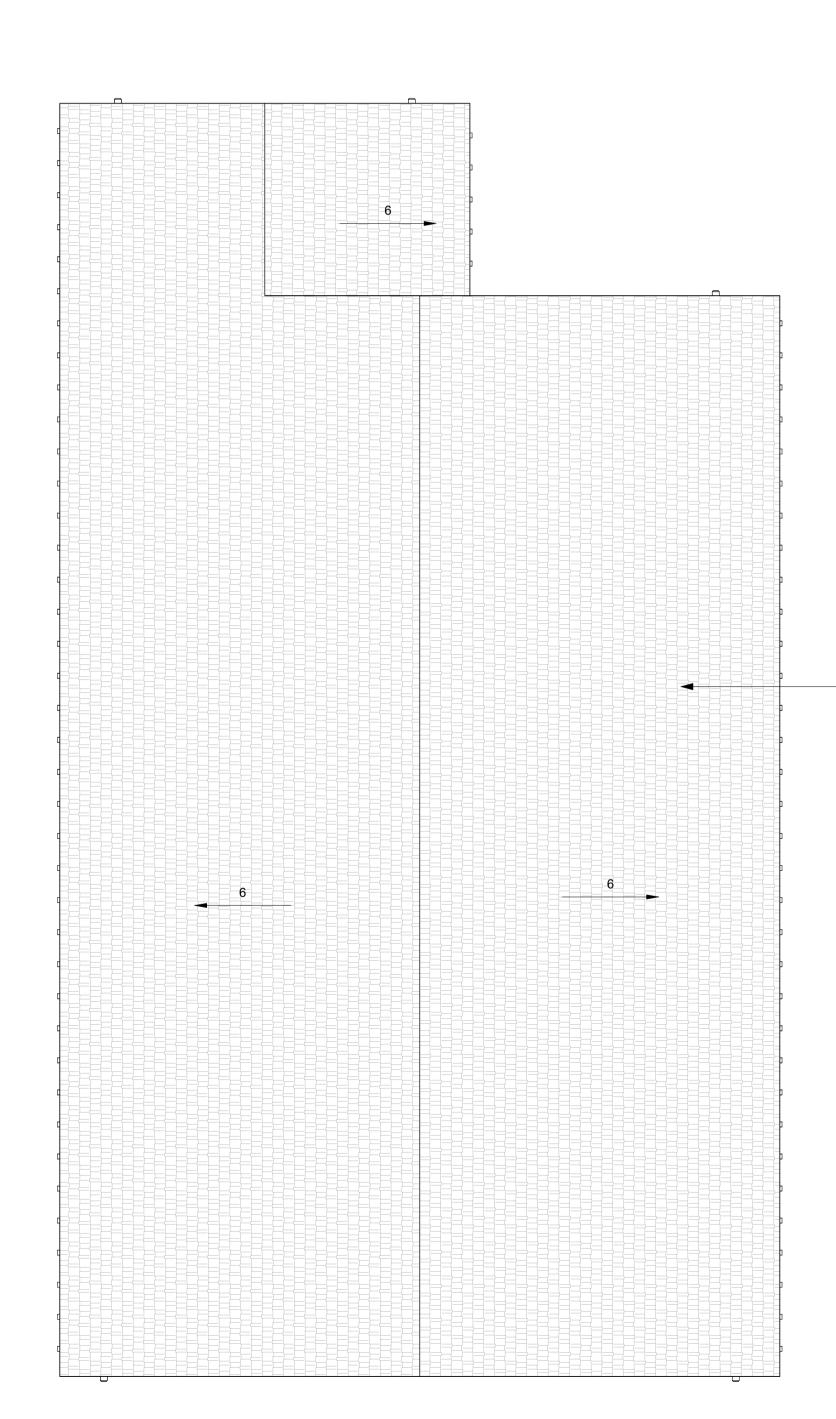


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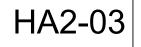
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507 E. 5th St	Enter address here	03 DESIGN + BUILD
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SHEET NUMBER



	ASPHALT SH HISTORIC W BEVEL SIDIN CRAFTSMAN HISTORIC D OVER 1 WO TAPERED W PARTIAL HE COLUMN BRICK COLL St Floor 0' - 0" Grade -1' - 8"	VOOD S NG, 4' R N GABL OUBLE OD WIN VOOD C IGHT B JMNS	IDING EVEAL E BRACKET -HUNG 1 IDOWS OLUMN ON			401 COSMOS ST. HOUSTON TX 77009 1 832.287.1153	
ASPHALT SHINLE SOFFITED EAVE WOOD WINDOW 1-0" HARDI LAP SIDIN	- 11 1/4"		<u>Top Plate</u> 19' - 0" <u>Cond Floor</u> 10' - 0" <u>10' - 0" Grade</u> -1' - 8"		SUE NAME		
				-	HEET NAME	 Elevations	

