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**4X4 ALL TERRAIN** 2 STORY HOUSE 1ST FLOOR AREA: 897 GSF FRONT PATIO: 238 GSF 2ND FLOOR AREA: 624 GSF 1,521 SQ. FT. OF NET AREA 1,759 SQ. FT. OF GROSS AREA (INCLUDES FRONT PORCH)

THIS RESILIENT SINGLE-FAMILY HOME WAS DESIGNED TO BLEND WITHIN AN ECLECTIC ARRAY OF SIZES, SHAPES, FORMS AND MATERIALS FOUND IN THE HOUSTON NEIGHBORHOODS CONTEXT.

A COMBINATION OF WOOD LOOK (FIBER CEMENT SIDING) AND METAL SIDING MATERIAL WERE CHOSEN FOR THE AESTHETICS, AND LOW MAINTENANCE. THE 4X4 MODULAR GRID WAS USED FOR THE LAYOUT OF THE FLOOR PLAN TO ACHIEVE AN EFFICIENT AND FUNCTIONAL HOME. THE DOUBLE HEIGHT SPACE CELEBRATES THE LIVING, DINING AREA. DAYLIGHT POURS INTO THE LIVING AND DINING AREA FROM THE ENTRY DOOR AND CORNER WINDOWS COMBINATION. THE ARCHITECTURE WILL SET SOME STANDARDS OF DESIGN ASPIRATION FOR THE FUTURE OF THE AREA, USING SUSTAINABLE BUT ALSO AFFORDABLE BUILDING PRACTICES WITH HIGH IMPACT DESIGN.

FEATURES: MINIMAL DISTURBED LANDSCAPE NATURAL PATH RUN OFF WITH MINIMAL REGRADING MINIMAL FOOTPRINT (FIT ON SMALL LOTS) NO FILL MATERIAL BROUGHT TO SITE MINIMAL USE OF IMPERVIOUS MATERIAL SIMPLE AND ELEVATED FOUNDATION ELEVATED LIVING AND RAISED MECHANICAL AND ELECTRICAL EQUIPMENT ADA ACCESSIBLE FIRST LEVEL HOME SOLAR EXTERIOR PATH LIGHTS

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#### REVISION:

SET DATED:11.20.2021 SET DATED:09.27.2021 SET DATED:08.23.2021 SET DATED:04.04.2021


SET DATED:03.15.2021

PROJECT NAME:

### **4X4 ALL TERRAIN** SINGLE FAMILY RESIDENCE

PROJECT LOCATION: 4600 ROBERTSON STREET Houston, Texas 77009

OWNER: CITY OF HOUSTON HOUSING AND COMMUNITY DEVELOPMENT DEPT. 2100 TRAVIS STREET | 9TH FLOOR | HOUSTON TX

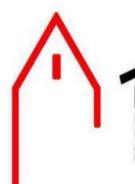







4X4 ALL TERRAIN

DRAWING NAME: **COVER SHEET** 

A-00 SHEET

## STABILIZED CONSTRUCTION ACCESS **GENERAL NOTES:** MINIMUM LENGTH IS AS SHOWN ON CONSTRUCTION

DRAWINGS CONSTRUCT AND MAINTAIN CONSTRUCTION EXIT WITH CONSTANT WIDTH ACROSS ITS LENGTH UNLESS SHOWN ON THE CONSTRUCTION DRAWINGS, STABILIZATION FOR OTHER AREAS WILL HAVE THE SAME AGGREGATE THICKNESS AND WIDTH REQUIREMENTS AS THE STABILIZED CONSTRUCTION EXIT. WHEN SHOWN ON THE CONSTRUCTION DRAWINGS, WIDEN OR LENGTHEN STABILIZED AREA TO ACCOMMODATE A TRUCK WASHING AREA. PROVIDE PERIODIC TOP DRESSING WITH ADDITIONAL COARSE AGGREGATE TO MAINTAIN THE REQUIRED DEPTH OR WHEN SURFACE BECOMES PACKED WITH MUD. PERIODICALLY TURN AGGREGATE TO EXPOSE A CLEAN

DRIVING SURFACE.

#### 6:1 TYP. **EXISTING** GROUND 2/2/2/2/ SEPARATION GEOTEXTILE FABRIC FOR FULL WIDTH AND LENGTH OF EXIT

COARSE AGGREGATE -MIN. 2" GRANULAR FILL. BULL ROCK (CRUSHED CONCRETE) IS PERMITTED)


CONSTRUCTION PUBLIC WORK ZONE R-O-W

PROVIDE APPROPRIATE TRANSITION BETWEEN STABILIZED CONSTRUCTION -ENTRANCE AND PUBLIC RIGHT-OF-WAY <u>PLAN</u>


SECURE WIRE FENCE TO POSTS.


FLOW

**SILT FENCE:** 

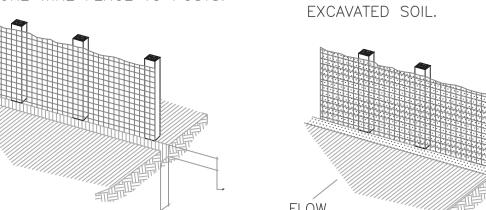

ALONG THE LINE OF POSTS AND

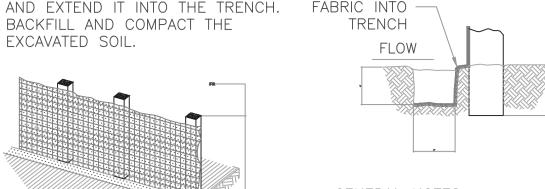

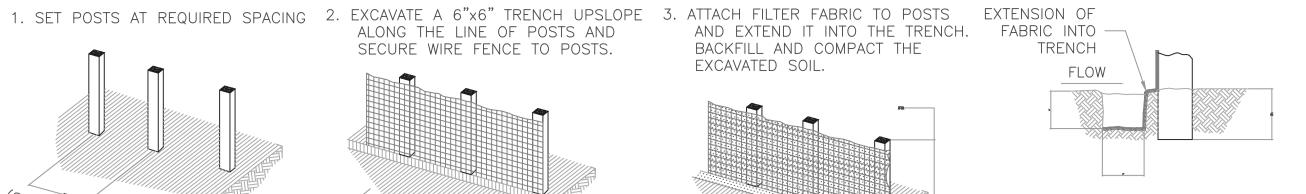



#### **GENERAL NOTES:**

- SECURELY FASTEN MESH FENCING TO POSTS WITH STAPLES OR TIE WIRES. SECURELY FASTEN FILTER FABRIC TO MESH FENCING.
- 3. WHEN TWO SECTIONS OF FILTER FABRIC ADJOIN EACH OTHER, OVERLAP 6 INCHES AT A POST, FOLD
- TOGETHER, AND ATTACH TO A POST. 4. REMOVE SEDIMENT DEPOSITS WHEN SILT REACHES ONE-THIRD OF THE HEIGHT OF THE FENCE IN DEPTH.





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SET DATED:04.04.2021

SET DATED:03.15.2021 **REVISED: 01.03.2022** REVISED: 01.29.2022 REVISED: 02.15.2022

### PROJECT NAME:

### **4X4 ALL TERRAIN** SINGLE FAMILY RESIDENCE

PROJECT LOCATION: 4600 ROBERTSON STREET Houston, Texas 77009

## OWNER:

CITY OF HOUSTON HOUSING AND COMMUNITY DEVELOPMENT DEPT 2100 TRAVIS STREET | 9TH FLOOR | HOUSTON TX 77002







A HOUSING AND URBAN DESIGN COMPETITION


A HOUSING AND URBAN DESIGN COMPETITION


4X4 ALL TERRAIN

DRAWING NAME: **EROSION CONTROL PLAN** 

C-00

SHEET

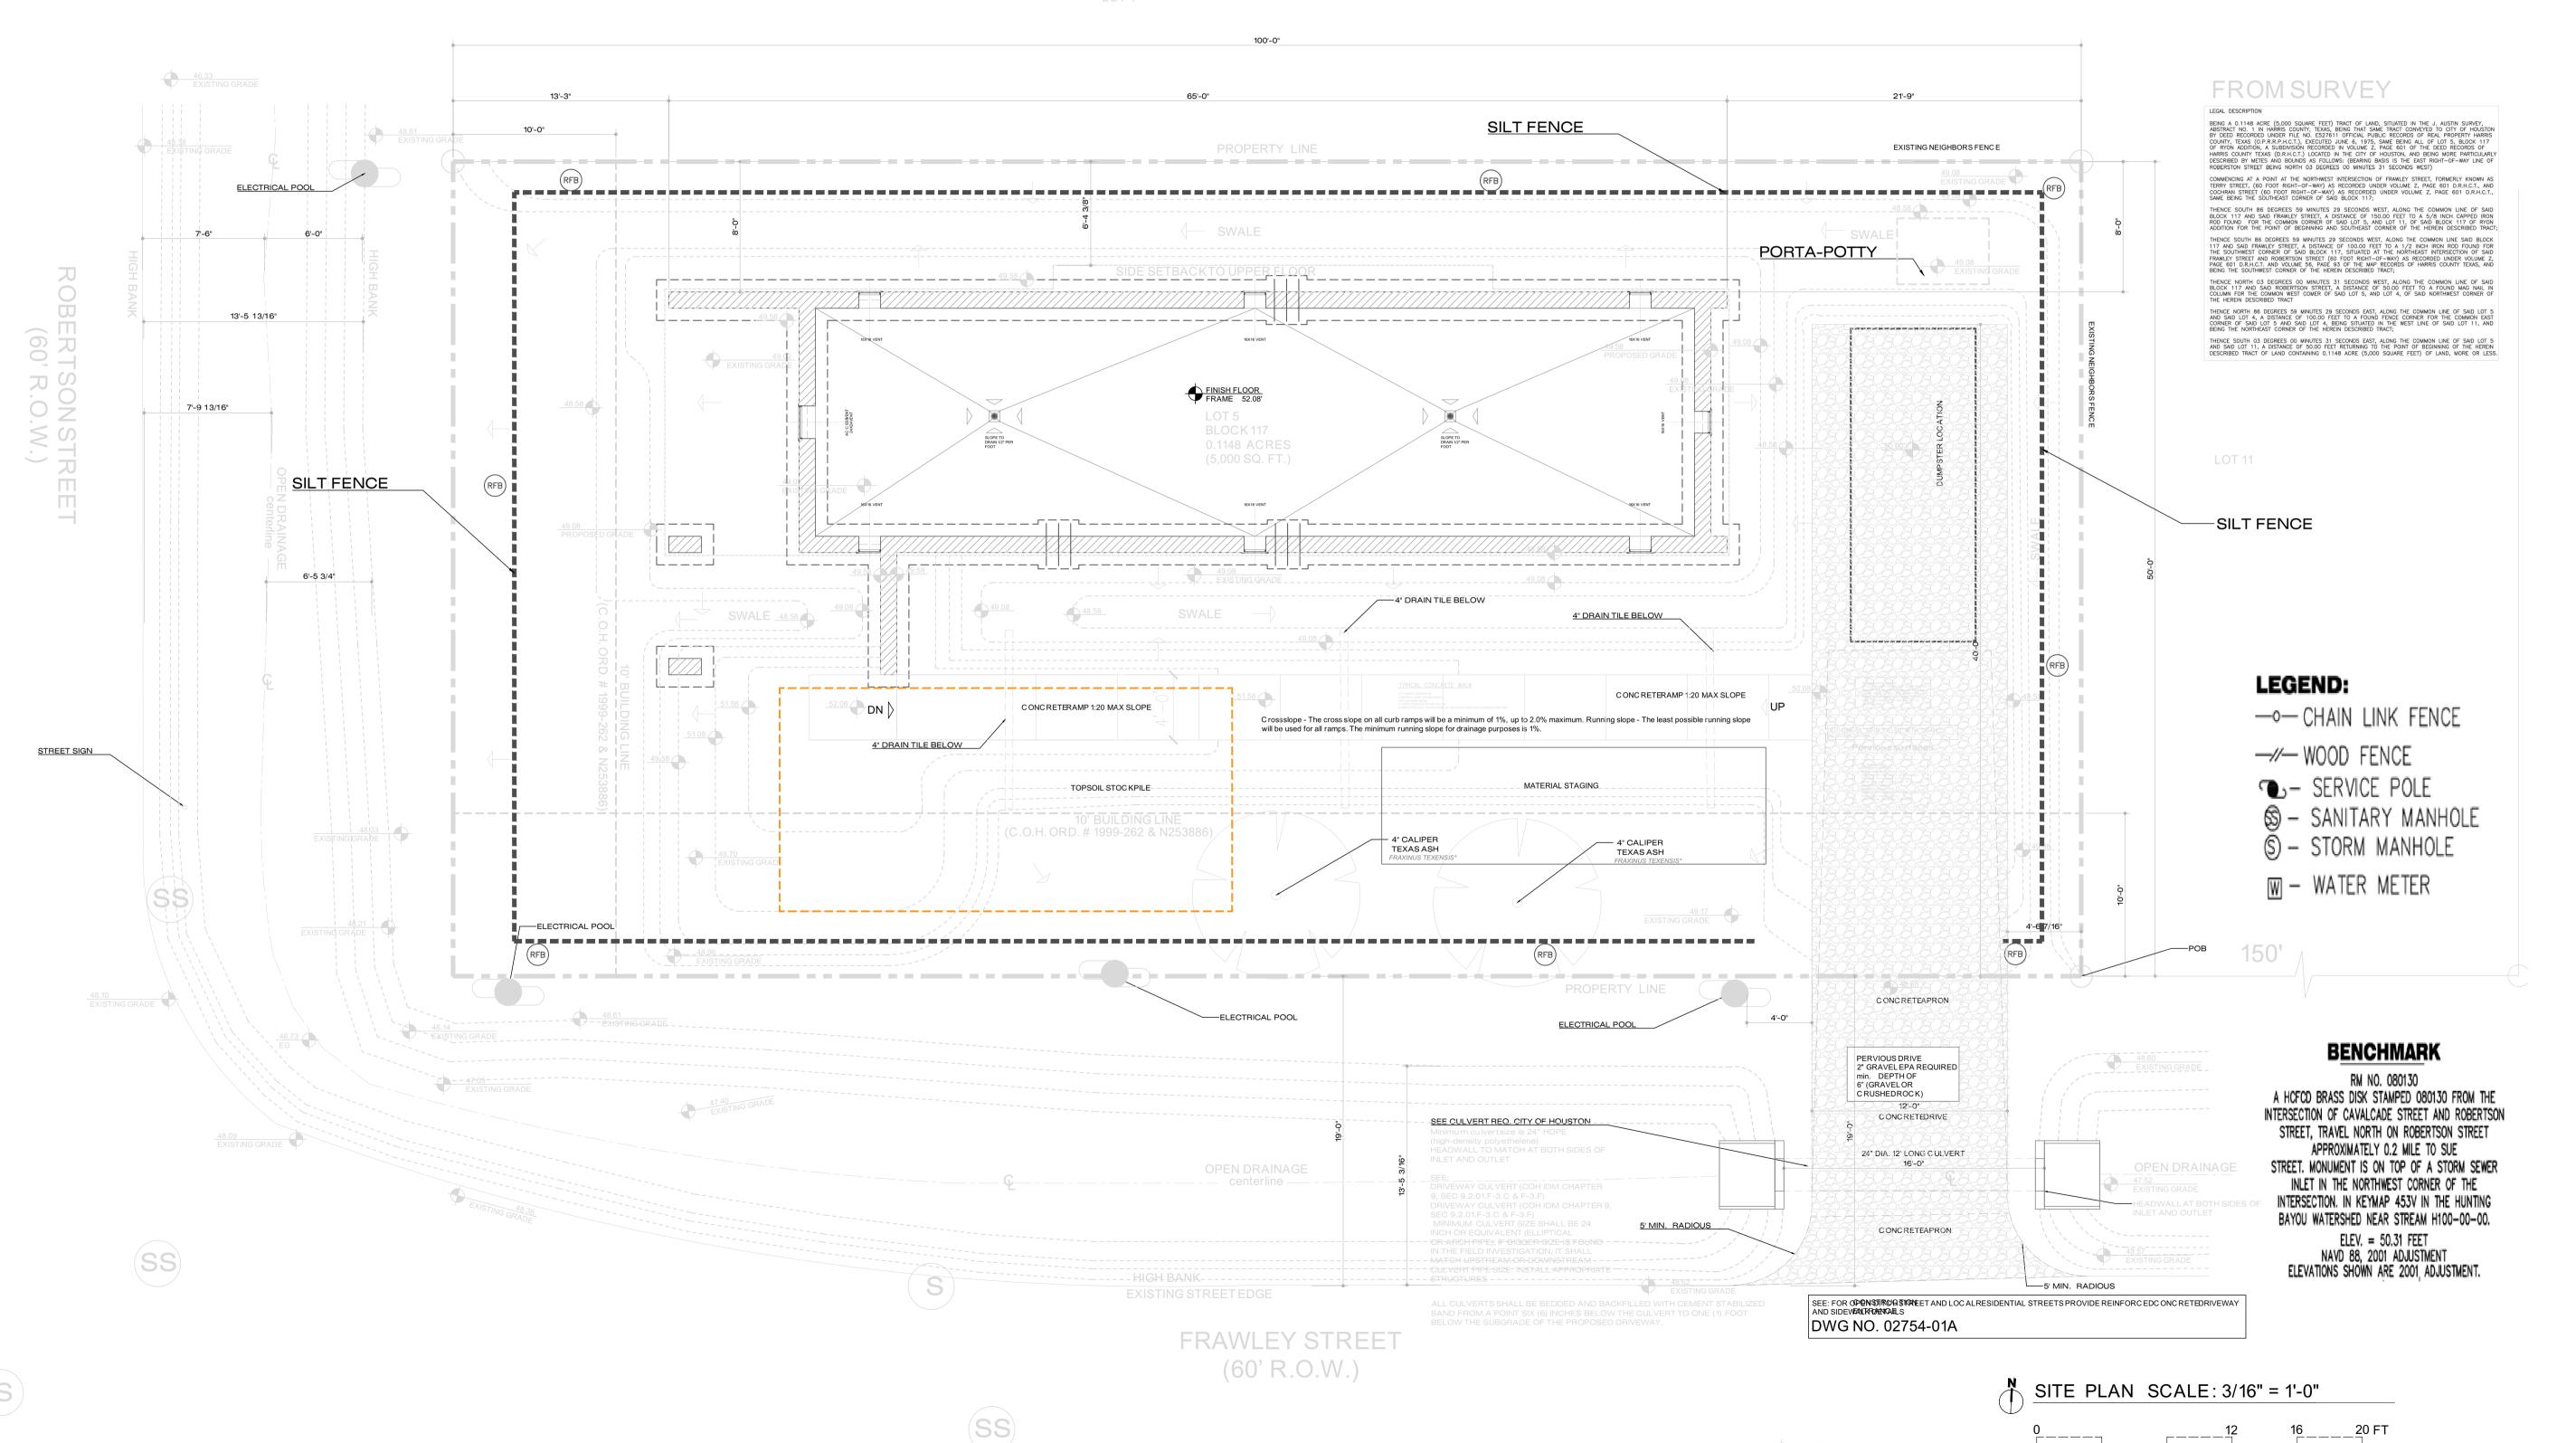

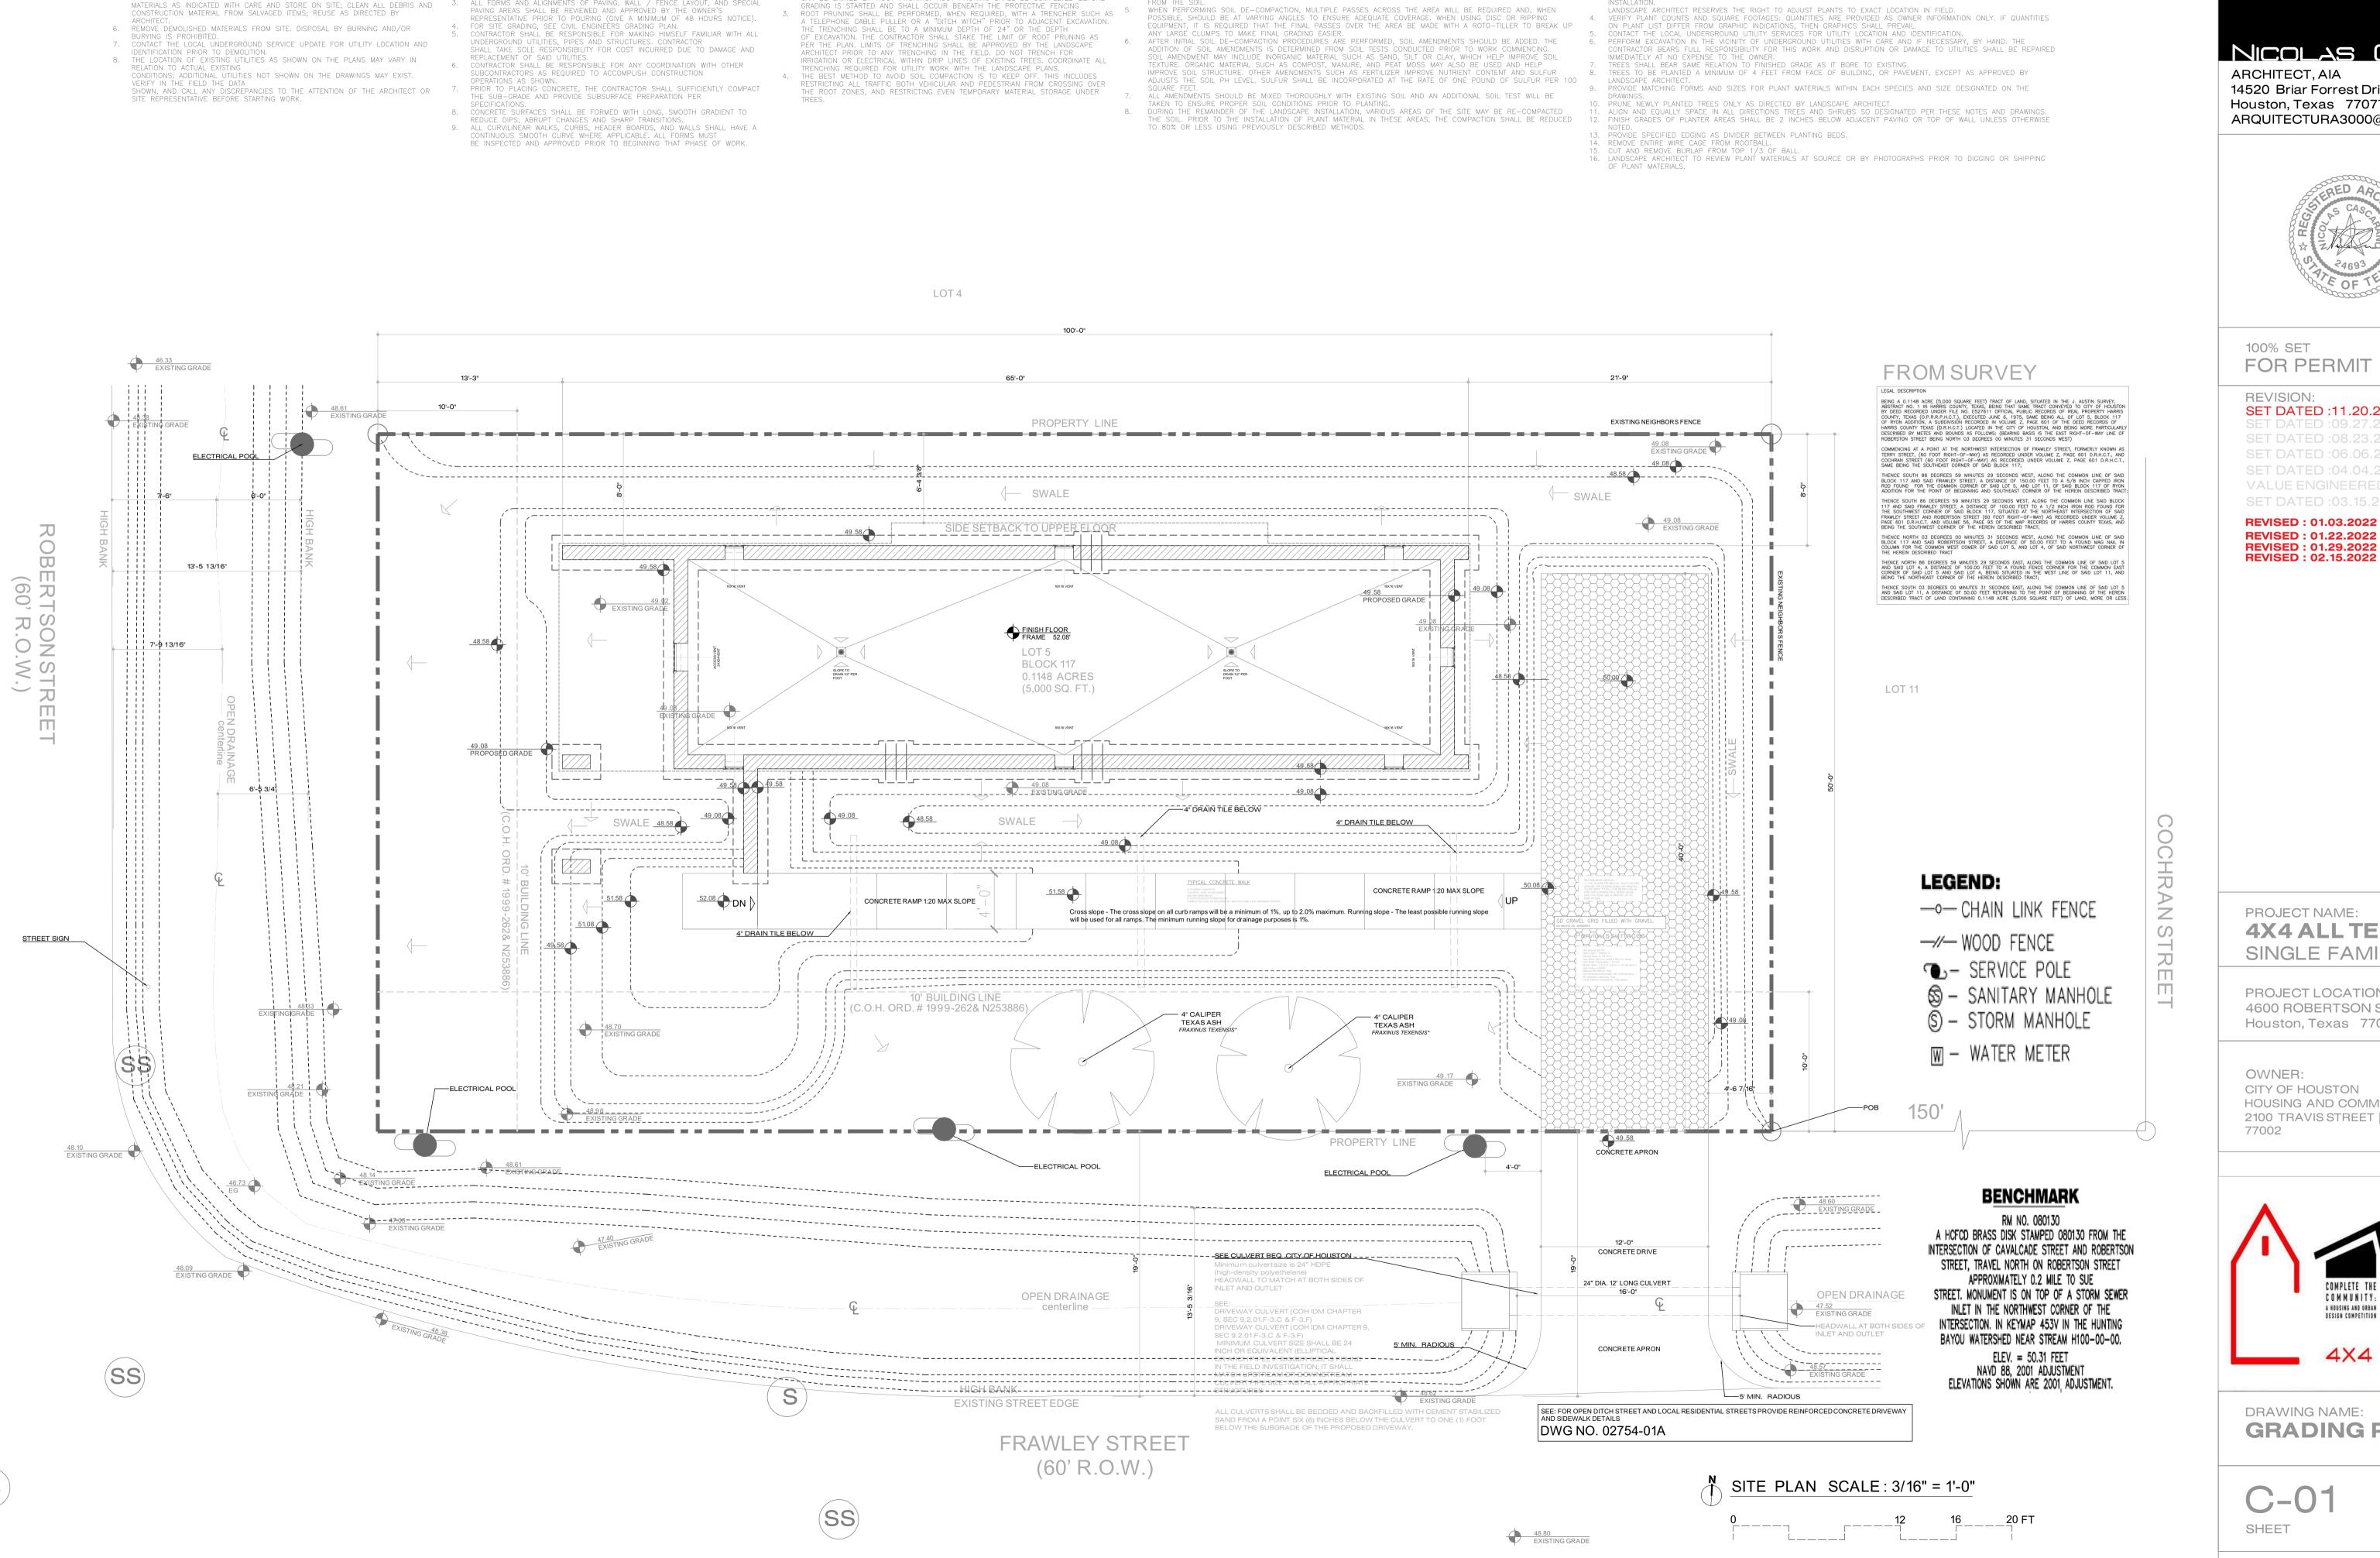

LANDSCAPE PLANTING NOTES

CONTRACTOR TO DE-COMPACT SOILS IN PLANTING AREAS BY ROTO-TILLING, DISKING OR RIPPING TO A DEPTH OF 6 3. EXACT LOCATIONS OF PLANT MATERIALS TO BE APPROVED BY THE LANDSCAPE ARCHITECT IN THE FIELD PRIOR TO

REFER TO CIVIL ENGINEER'S UTILITY AND GRADING AND DRAINAGE PLANS FOR UTILITY LOCATION AND DRAINAGE

REFER TO CIVIL ENGINEER'S GRADING PLANS FOR GRADING INFORMATION. IF ACTUAL SITE CONDITIONS VARY FROM WHAT IS

SHOWN ON THE PLANS OR IF THERE ARE DISCREPANCIES BETWEEN THE PLANS, CONTACT THE CIVIL ENGINEER AND ARCHITECT FOR DIRECTION AS TO HOW TO PROCEED.

CANNOT BE FOLLOWED DUE TO SITE CONDITIONS, CONTACT LANDSCAPE ARCHITECT FOR INSTRUCTIONS PRIOR TO

SOIL PREPARATION OF A LANDSCAPE DESIGN IS A CRITICAL FACTOR IN CREATING A HEALTHY AND LONG-LASTING

THE IDEAL PARTICLE SOIL MIX IS APPROXIMATELY 45% SAND, 40% SILT, 10% CLAY AND 5% ORGANIC MATERIAL WITH

REMOVE EXISTING TOPSOIL AND STOCKPILE ON SITE. TOPSOIL TO BE INCORPORATED BACK INTO THE SITE SOIL AT A LATER DATE. CONTRACTOR TO CONDUCT A SOIL EVALUATION TO DETERMINE THE SOIL'S COMPOSITION, COMPACTION RATE, NUTRIENT QUALITIES, ORGANIC CONTENT, PH LEVELS, AND WATER HOLDING CAPABILITIES.

PRIOR TO THE INSTALLATION OF THE LANDSCAPE, CONTRACTOR TO PREPARE SOIL TO ENSURE A PROPER

SITE DEMOLITION NOTES

1. ITEMS SHALL REMAIN UNLESS DESIGNATED FOR REMOVAL. REMOVE DESIGNATED

2. VERIFY THE LOCATION AND DIMENSION OF ITEMS TO BE REMOVED PRIOR TO

ITEMS SHOWN ON THE PLAN TO THE FULL DEPTH OF THEIR CONSTRUCTION

VERIFY THE LOCATION AND DIMENSION OF THEMS TO BE REMOVED THROUGH COMMENCEMENT OF THE WORK.

ALLL CONCRETE AND ASPHALT REMOVAL SHALL BE SAW CUT. EDGES OF MATERIAL TO REMAIN SHALL BE SORRED UP AND PROTECTED DURING CONSTRUCTION TO PRESERVE EDGE INTACT. REPAIRS TO DAMAGED EDGES TO BE DONE WITH CARE

ITEMS ENCOUNTERED BELOW GRADE AND NOT SHOWN ON THE DRAWINGS SHALL BE BROUGHT TO THE ATTENTION OF THE ARCHITECT.

SALVAGE EXISTING MATERIALS AS INDICATED ON THE PLANS. REMOVE SALVAGED
MATERIALS AS INDICATED WITH CARE AND STORE ON SITE; CLEAN ALL DEBRIS AND

CONSTRUCTION NOTES

CONTRACTOR SHALL NOT WILLFULLY PROCEED WITH CONSTRUCTION AS DESIGNED

GRADE DIFFERENCES EXIST THAT MAY NOT HAVE BEEN KNOWN DURING DESIGN. SUCH CONDITIONS SHALL BE IMMEDIATELY BROUGHT TO THE

RESPONSIBILITY FOR ALL NECESSARY REVISIONS DUE TO A FAILURE TO GIVE

WALL AND FENCE LAYOUT SHALL CONFORM TO PROPERTY LINE AND TOP OF

ALL FORMS AND ALIGNMENTS OF PAVING, WALL / FENCE LAYOUT, AND SPECIAL

SLOPE CONDITIONS. STAKING FOR LOCATION OF WALLS AND FENCES SHALL BE PROVIDED BY THE CIVIL ENGINEER PRIOR TO EXCAVATION OF

WHEN IT IS OBVIOUS THAT UNKNOWN OBSTRUCTIONS AND/OR

ATTENTION OF THE ARCHITECT. THE CONTRACTOR SHALL ASSUME FUL

TREE PRESERVATION PLANTING NOTES

ALL TREES TO BE PRESERVED AS INDICATED ON THE LANDSCAPE DEMOLITION PLAN

SHALL BE PROTECTED BY 6' MAIN LINK FENCE

THE FENCE SHALL BE LOCATED AT A 5 FT. RADIUS FROM THE EDGE OF THE TRUNK.

THE FENCE SHALL BE FIRMLY ANCHORED INTO THE GROUND AND SHALL REMAIN

UPRIGHT AND INTACT UNTIL ALL CONSTRUCTION ACTIVITY IS COMPLETE.

CONSTRUCTION ACTIVITIES OR STORAGE SHALL NOT OCCUR WITHIN THESE PROTECTED

AREAS. THE CONTRACTOR SHALL STAKE THE PROTECTIVE FENCING LOCATION. THE

LOCATION OF THE PROTECTIVE FENCING SHALL BE APPROVED ONSITE BY THE

LANDSCAPE ARCHITECT PRIOR TO THE START OF ANY SITE WORK.
WHEN EXCAVATION NEAR A TREE TO BE PROTECTED MUST BE CARRIED OUT, DAMAGE

AN BE LIMITED BY ROOT PRUNING. ROOT PRUNING SHALL BE COMPLETED BEFORE RADING IS STARTED AND SHALL OCCUR BENEATH THE PROTECTIVE FENCING

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PROJECT NAME:

**4X4 ALL TERRAIN** SINGLE FAMILY RESIDENCE

PROJECT LOCATION: 4600 ROBERTSON STREET Houston, Texas 77009

OWNER: CITY OF HOUSTON HOUSING AND COMMUNITY DEVELOPMENT DEPT 2100 TRAVIS STREET | 9TH FLOOR | HOUSTON TX






A HOUSING AND URBAN DESIGN COMPETITION

4X4 ALL TERRAIN

DRAWING NAME: **GRADING PLAN** 

C-01

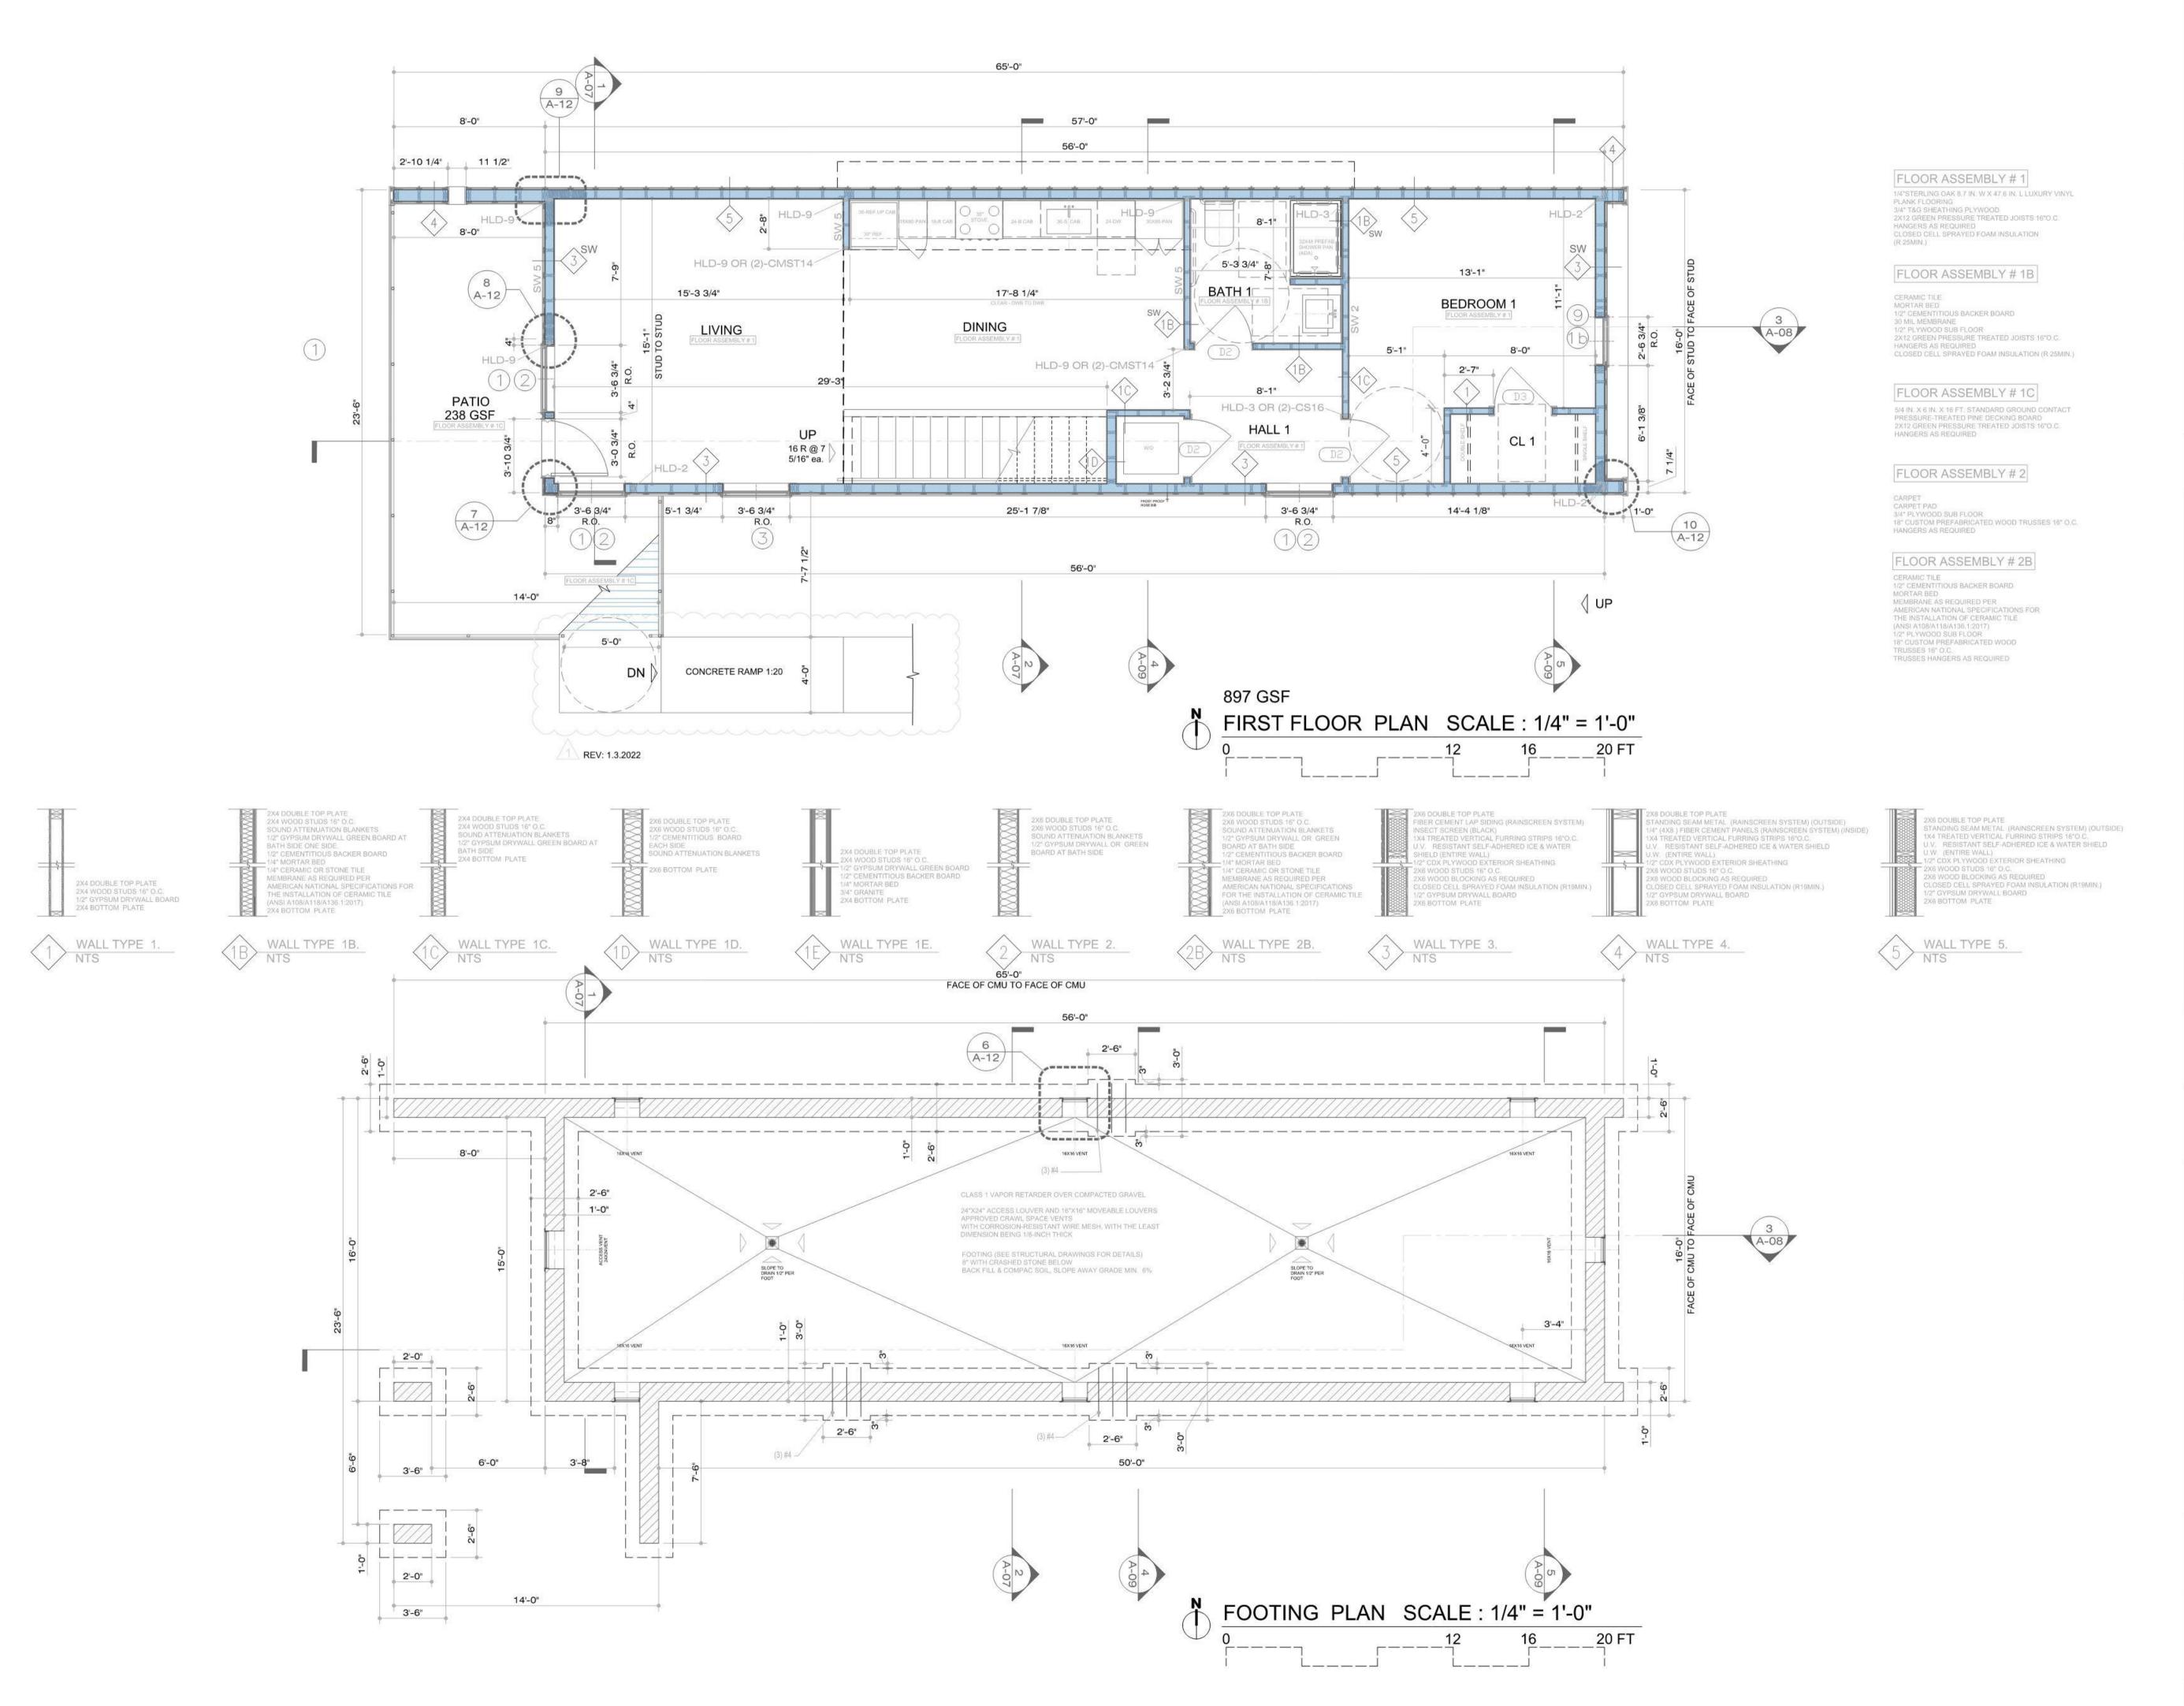

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#### **REVISED: 01.03.2022**

PROJECT NAME:

### **4X4 ALL TERRAIN** SINGLE FAMILY RESIDENCE

PROJECT LOCATION: 4600 ROBERTSON STREET Houston, Texas 77009

#### OWNER: CITY OF HOUSTON HOUSING AND COMMUNITY DEVELOPMENT DEPT. 2100 TRAVIS STREET | 9TH FLOOR | HOUSTON TX 77002








A HOUSING AND URBAN DESIGN COMPETITION

4X4 ALL TERRAIN

DRAWING NAME: **FLOOR PLANS** 

A-01 SHEET

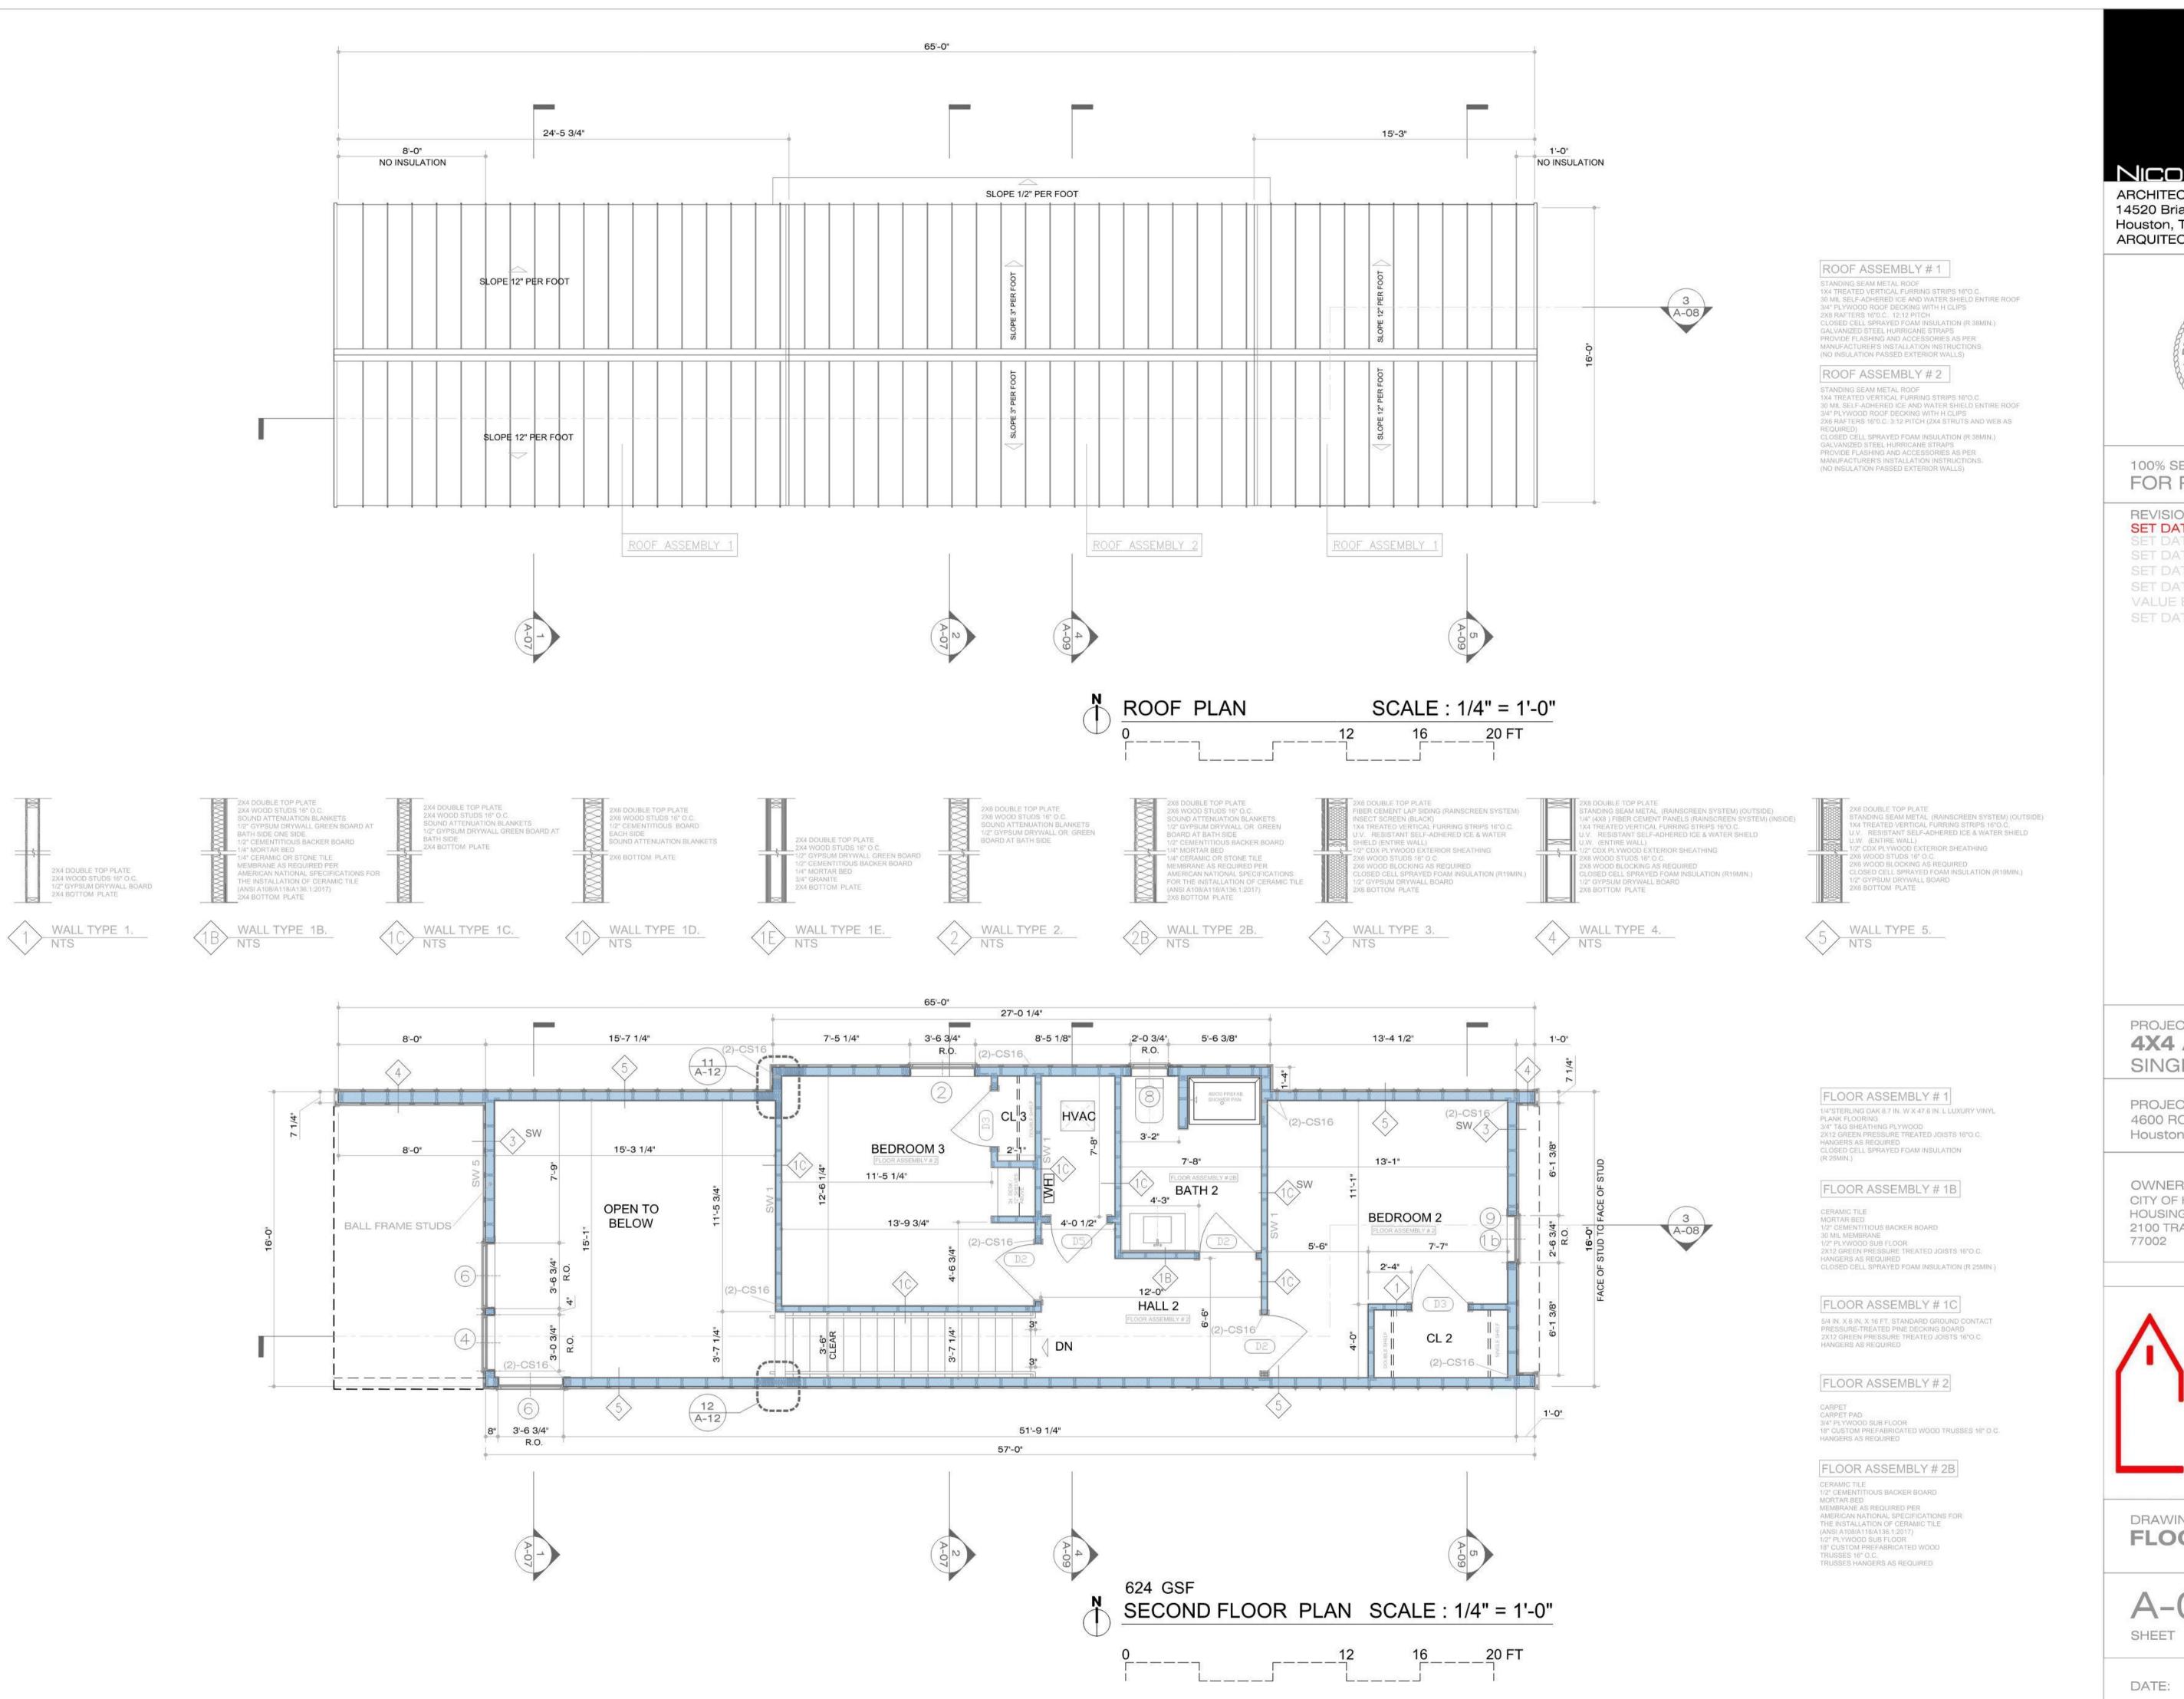

City of Houston

ARCHITECT, AIA 14520 Briar Forrest Drive #2308 Houston, Texas 77077 ARQUITECTURA3000@ATT.NET



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#### REVISION:

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PROJECT NAME:

### **4X4 ALL TERRAIN** SINGLE FAMILY RESIDENCE

PROJECT LOCATION: 4600 ROBERTSON STREET Houston, Texas 77009

OWNER: CITY OF HOUSTON HOUSING AND COMMUNITY DEVELOPMENT DEPT. 2100 TRAVIS STREET | 9TH FLOOR | HOUSTON TX








A HOUSING AND URBAN DESIGN COMPETITION

A HOUSING AND URBAN DESIGN COMPETITION

4X4 ALL TERRAIN

DRAWING NAME: **FLOOR PLANS** 

A-02

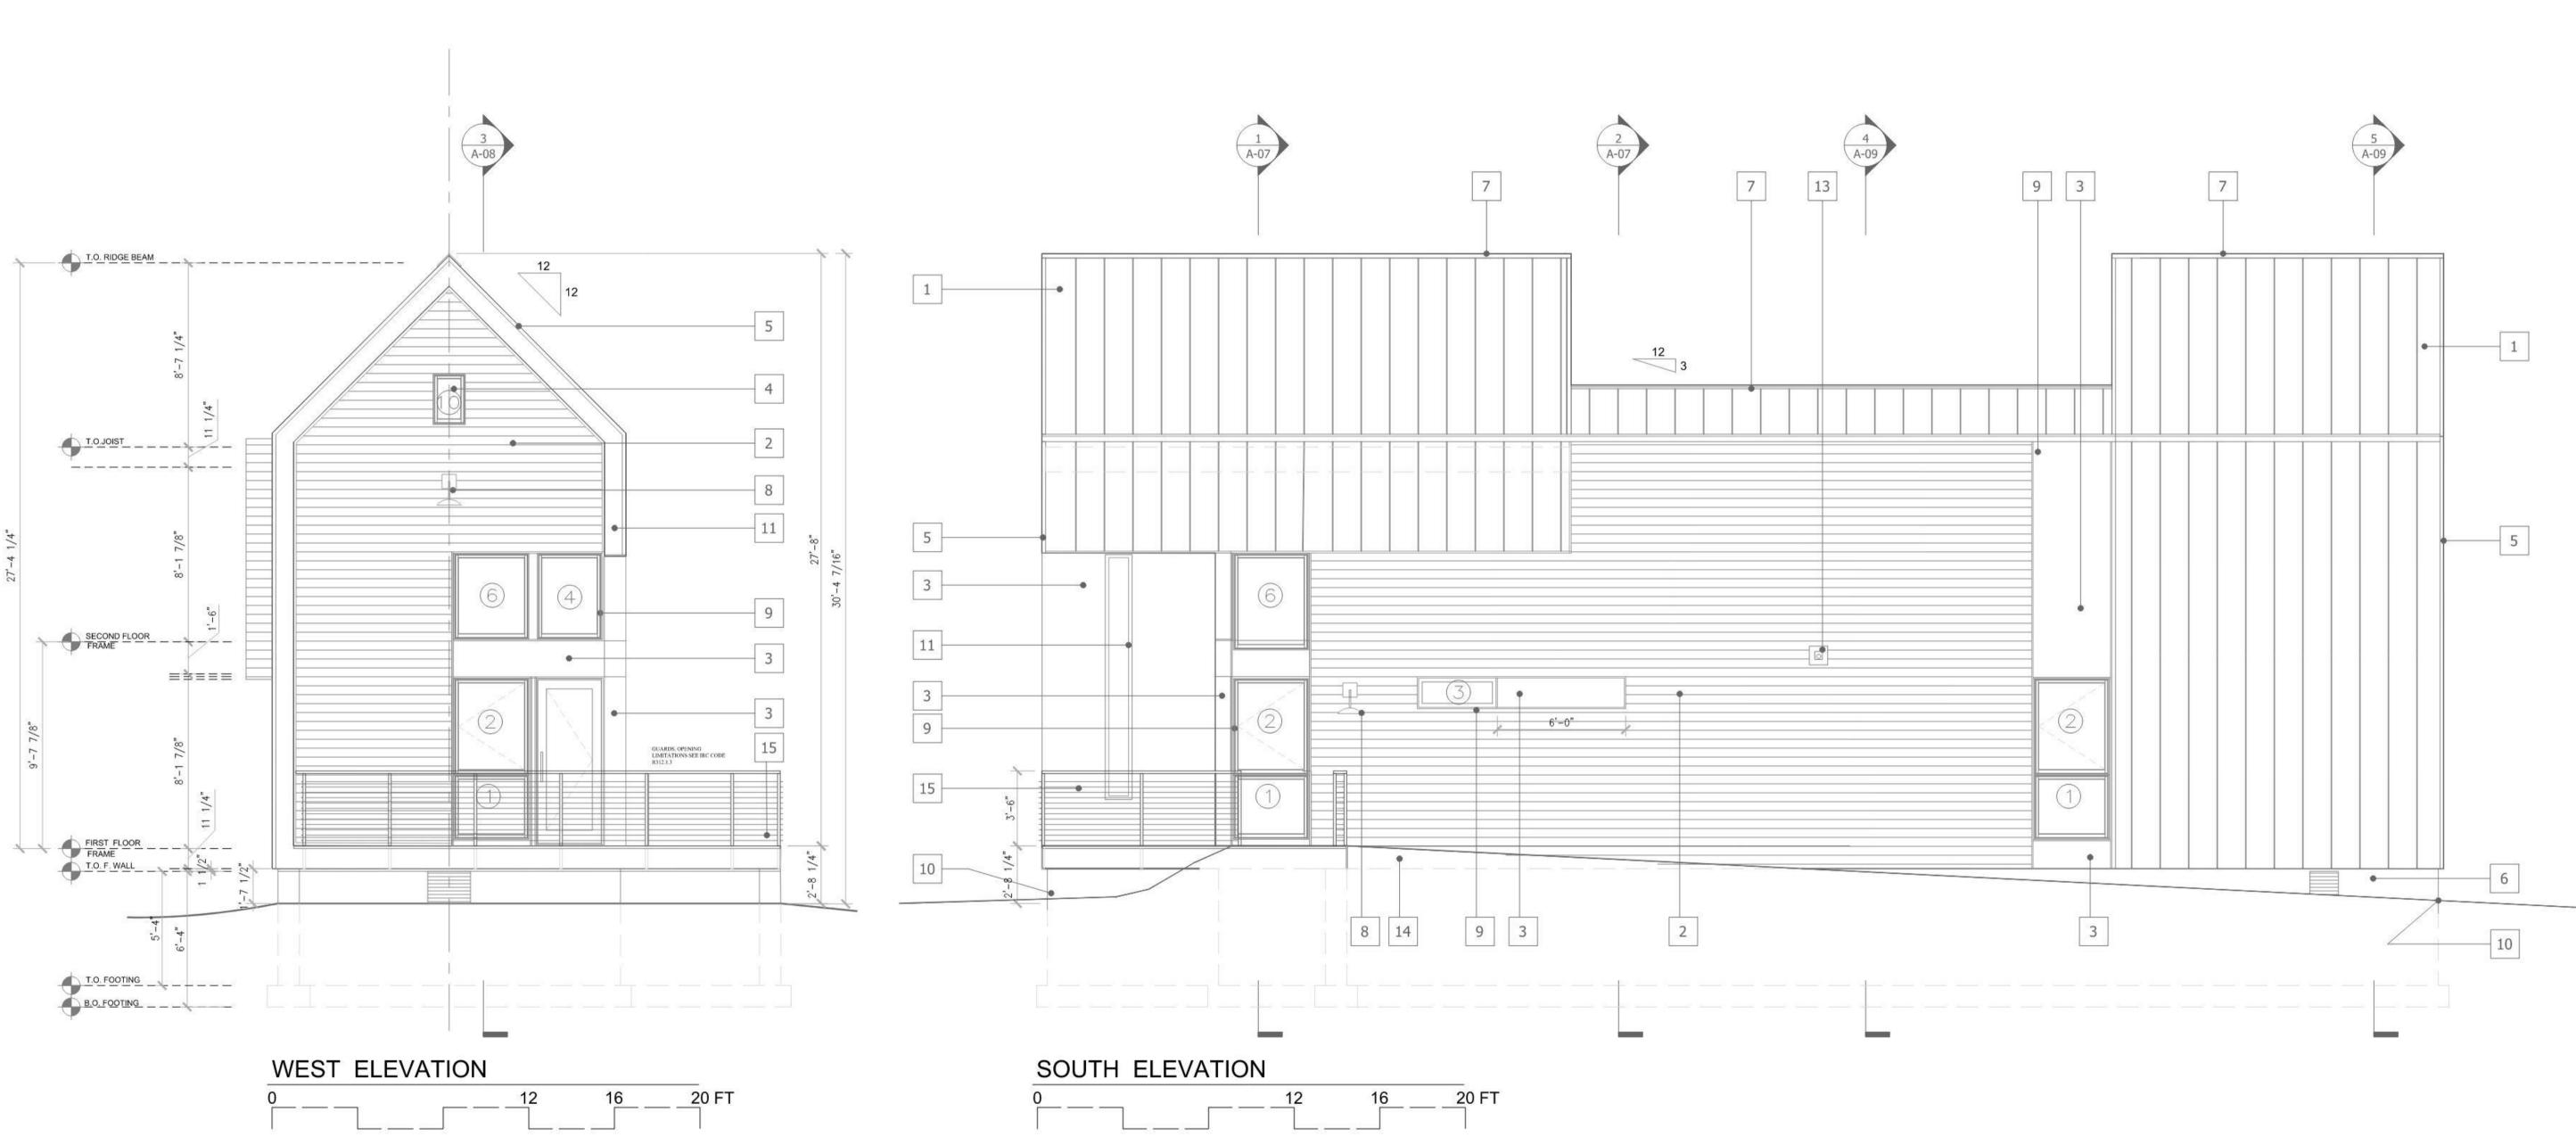



ARCHITECT, AIA 14520 Briar Forrest Drive #2308 Houston, Texas 77077 ARQUITECTURA3000@ATT.NET



#### 100% SET FOR PERMIT

### REVISION:

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SET DATED:04.04.2021

SET DATED:03.15.2021

#### REVISED: 01.03.2022

#### ELEVATION MATERIAL KEY

STANDING SEAM METAL PANELS - 16W PANELS

SL150-16" PANEL X 24 GAUGE - SMOOTH (MBCI)

FIBER CEMENT SIDING - WOOD TONE LAP SIDING - ALLURA (RAIN SCREEN SYSTEM) COLOR: MIXED

ASPEN RIDGE 70% + RIVER ROCK 30% - 4" EXPOSURE 3 HARDIESOFFIT PANEL SMOOTH.25"X24"X48"

4 CLERESTORY WINDOW - 18" X 28"

5 METAL CAP TO MATCH STANDING SEAM METAL

6 1/2" (ONE COAT) STUCCO PARGING (EXTERIOR PLASTER)

7 METAL - RIDGE/ Z ANGLE - TO MATCH

8 LIGHT FIXTURE ( WP - EXTERIOR)

9 .75" X 2.5"-HARDIETRIM SMOOTH BATTEN BOARDS

10 SLOPE 5% MIN AWAY FROM BUILDING

11 .75" X 11.25" - HARDIETRIM BOARD 4/4 SMOOTH

12 FRESH AIR VENT

13 DRYER VENT / EXHAUST VENT

14 CONCRETE LANDING SEE FLOOR PLAN

15 1.5"SQ. GALV. METAL GUARD RAILINGW.HORIZONTAL CABLE 3"O.G. SEE IRC CODE R312.1.3

PROJECT NAME:

### **4X4 ALL TERRAIN** SINGLE FAMILY RESIDENCE

PROJECT LOCATION: 4600 ROBERTSON STREET

Houston, Texas 77009

OWNER: CITY OF HOUSTON

HOUSING AND COMMUNITY DEVELOPMENT DEPT. 2100 TRAVIS STREET | 9TH FLOOR | HOUSTON TX 77002









A HOUSING AND URBAN DESIGN COMPETITION


4X4 ALL TERRAIN

DRAWING NAME: **ELEVATIONS** 

A-03 SHEET

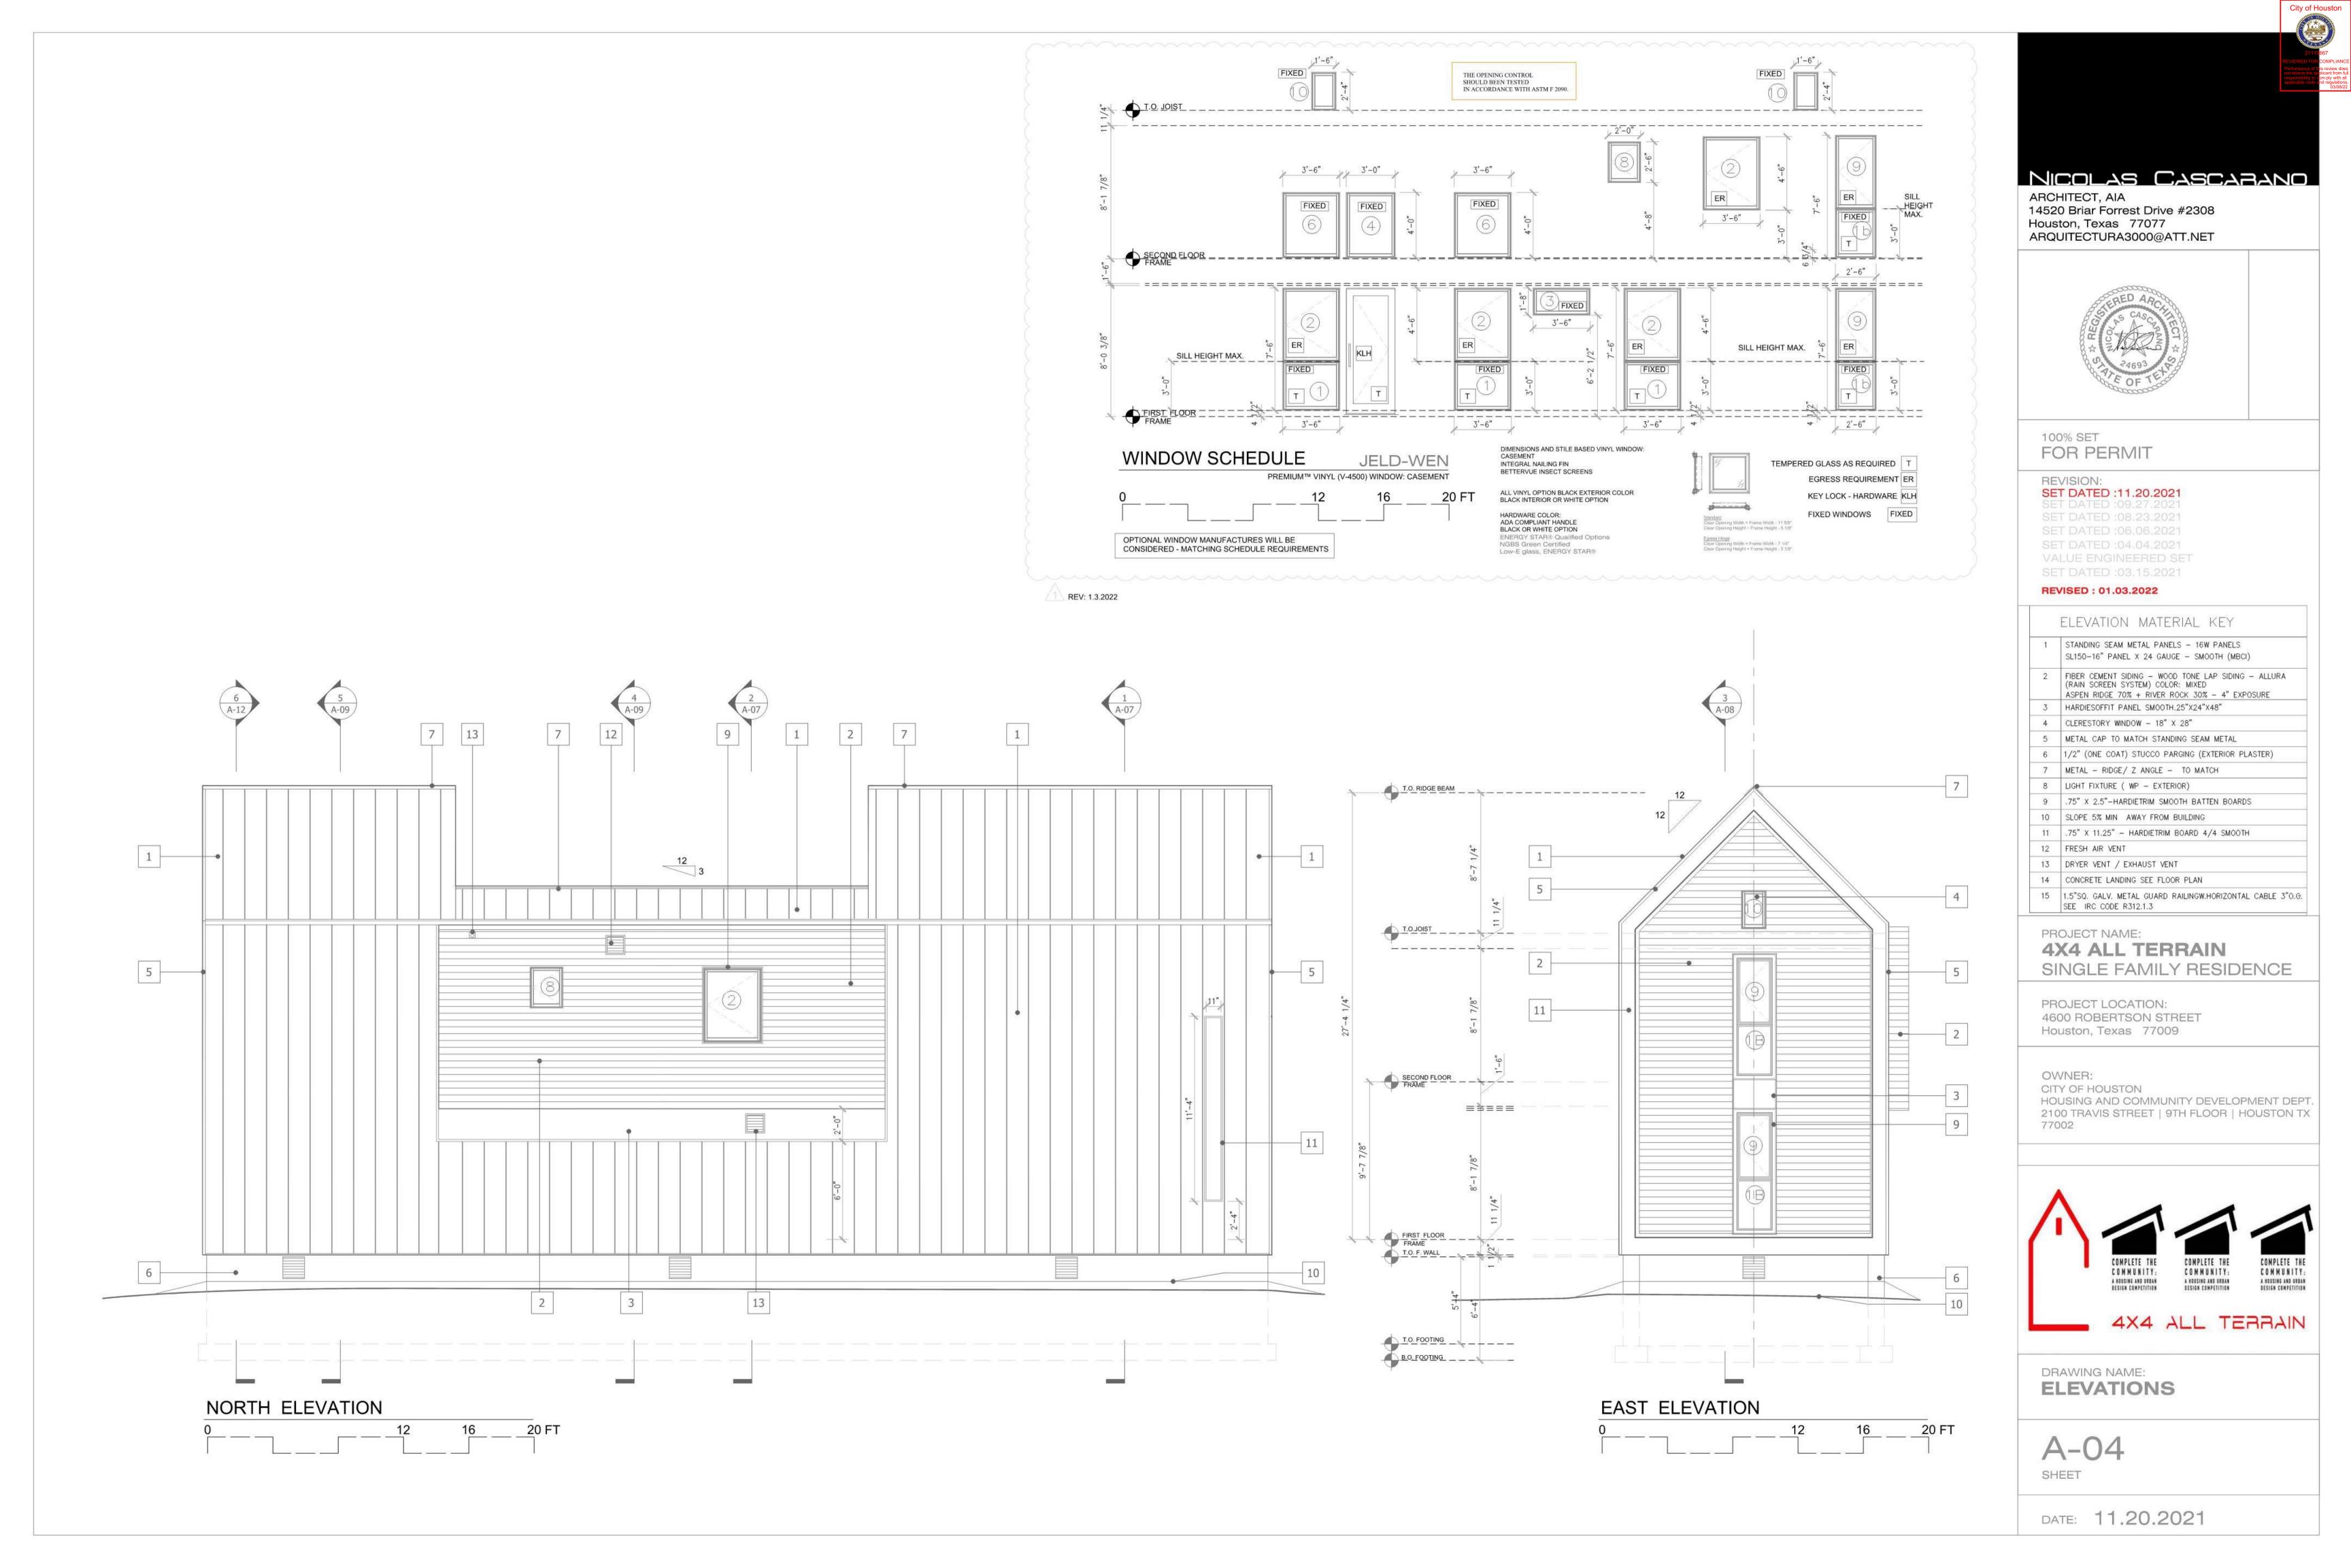

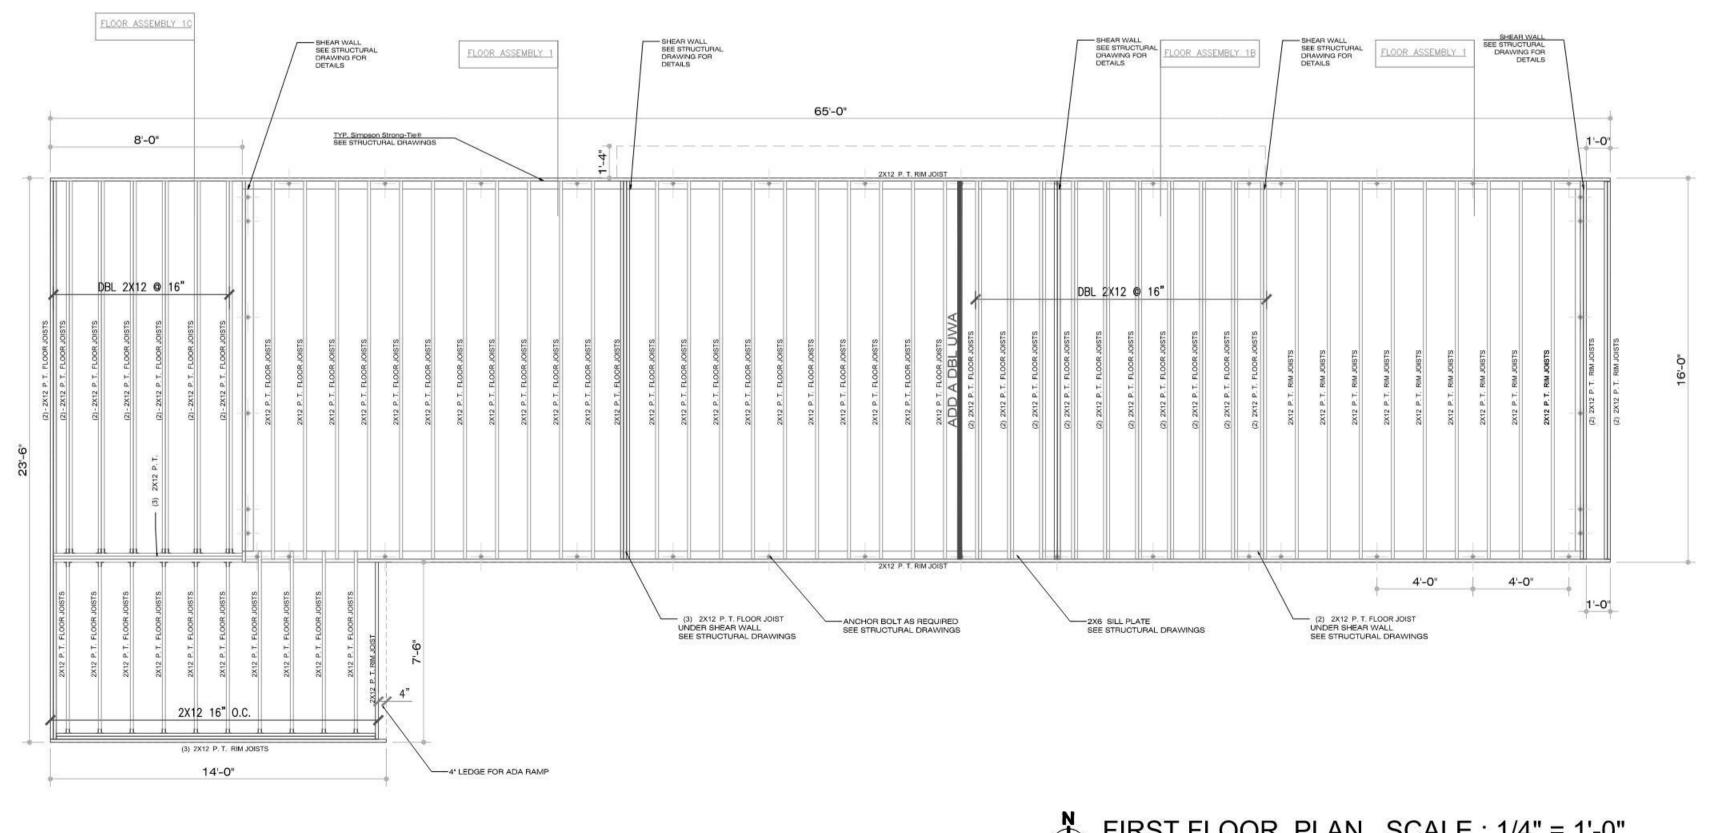

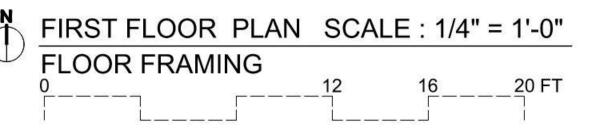

ARCHITECT, AIA 14520 Briar Forrest Drive #2308 Houston, Texas 77077 ARQUITECTURA3000@ATT.NET



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### PROJECT NAME:

### **4X4 ALL TERRAIN** SINGLE FAMILY RESIDENCE

PROJECT LOCATION: 4600 ROBERTSON STREET Houston, Texas 77009

#### OWNER: CITY OF HOUSTON HOUSING AND COMMUNITY DEVELOPMENT DEPT. 2100 TRAVIS STREET | 9TH FLOOR | HOUSTON TX 77002














4X4 ALL TERRAIN

DRAWING NAME: FRAMING PLANS

A-05 SHEET

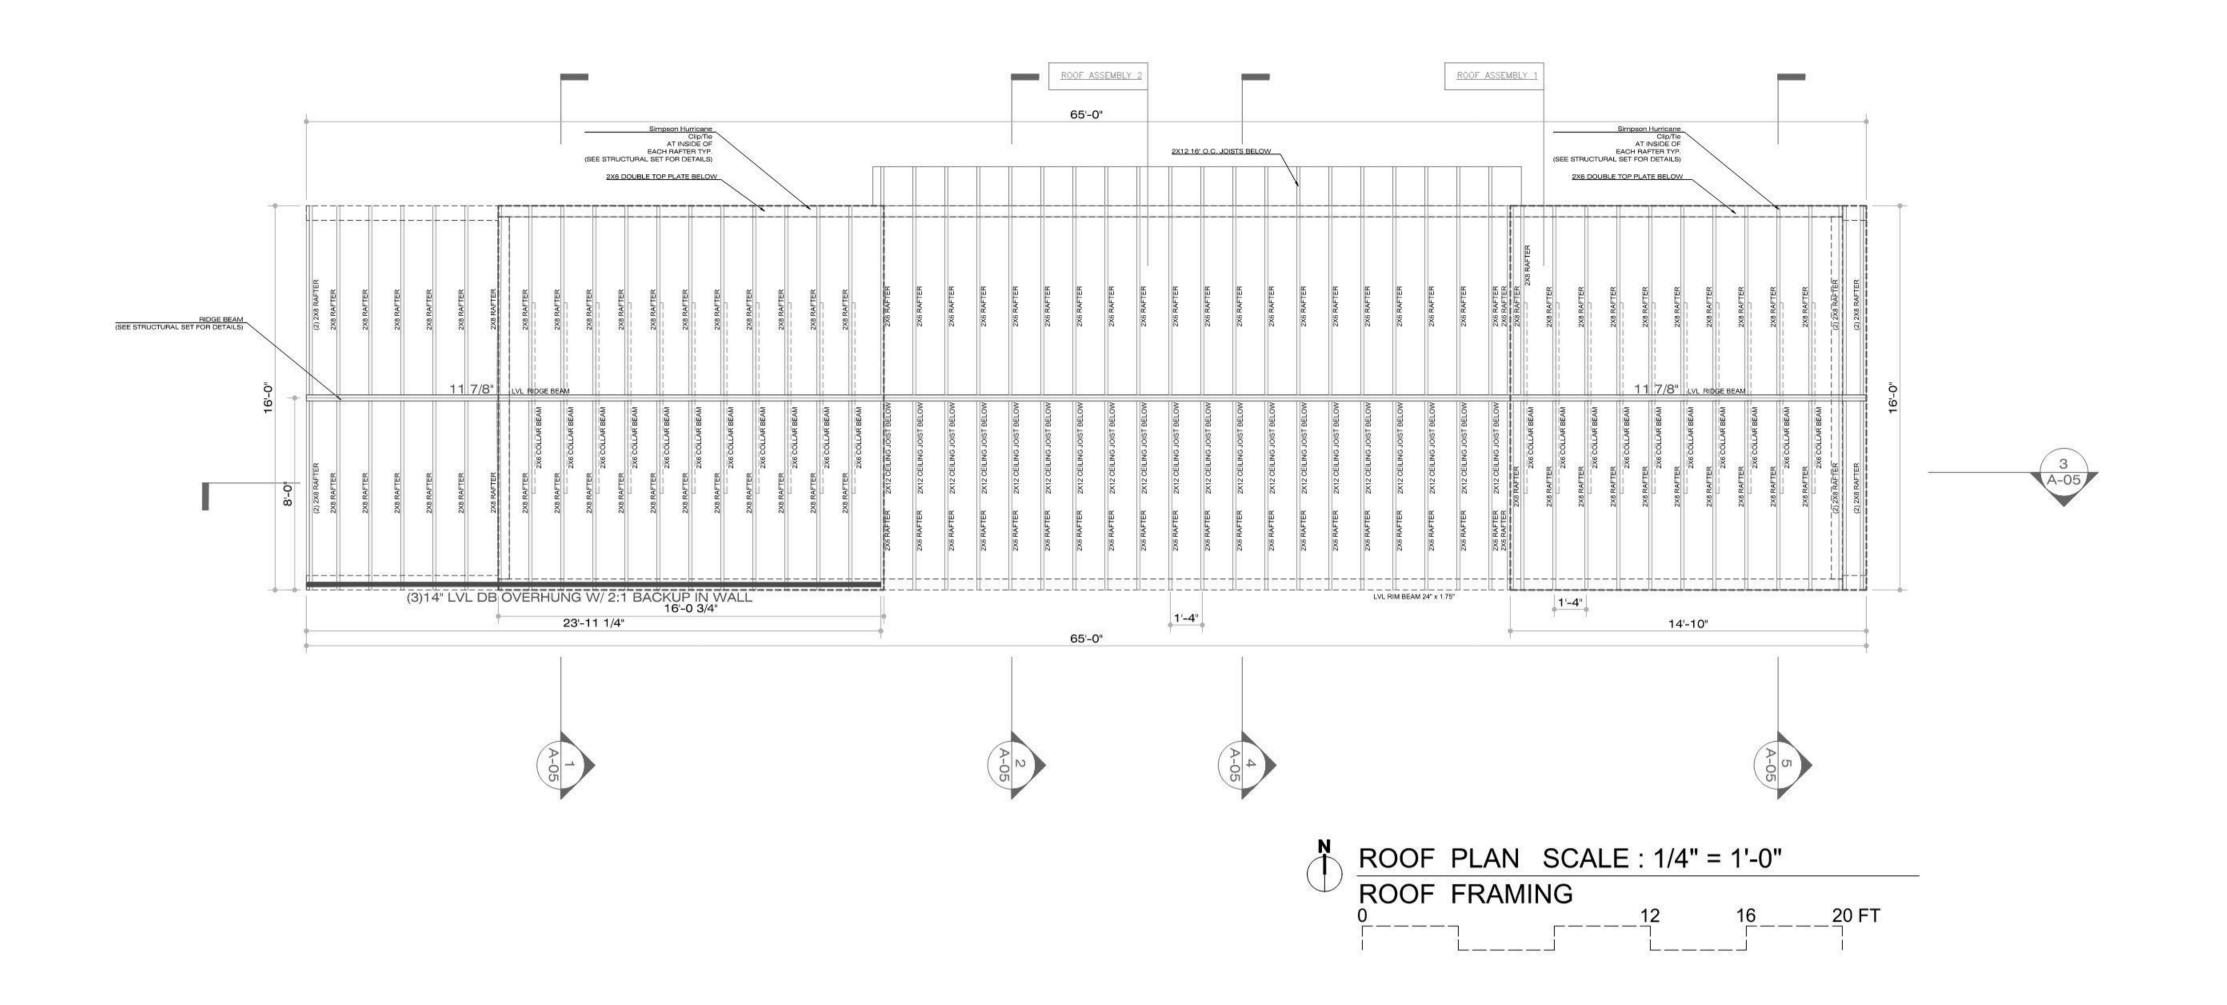

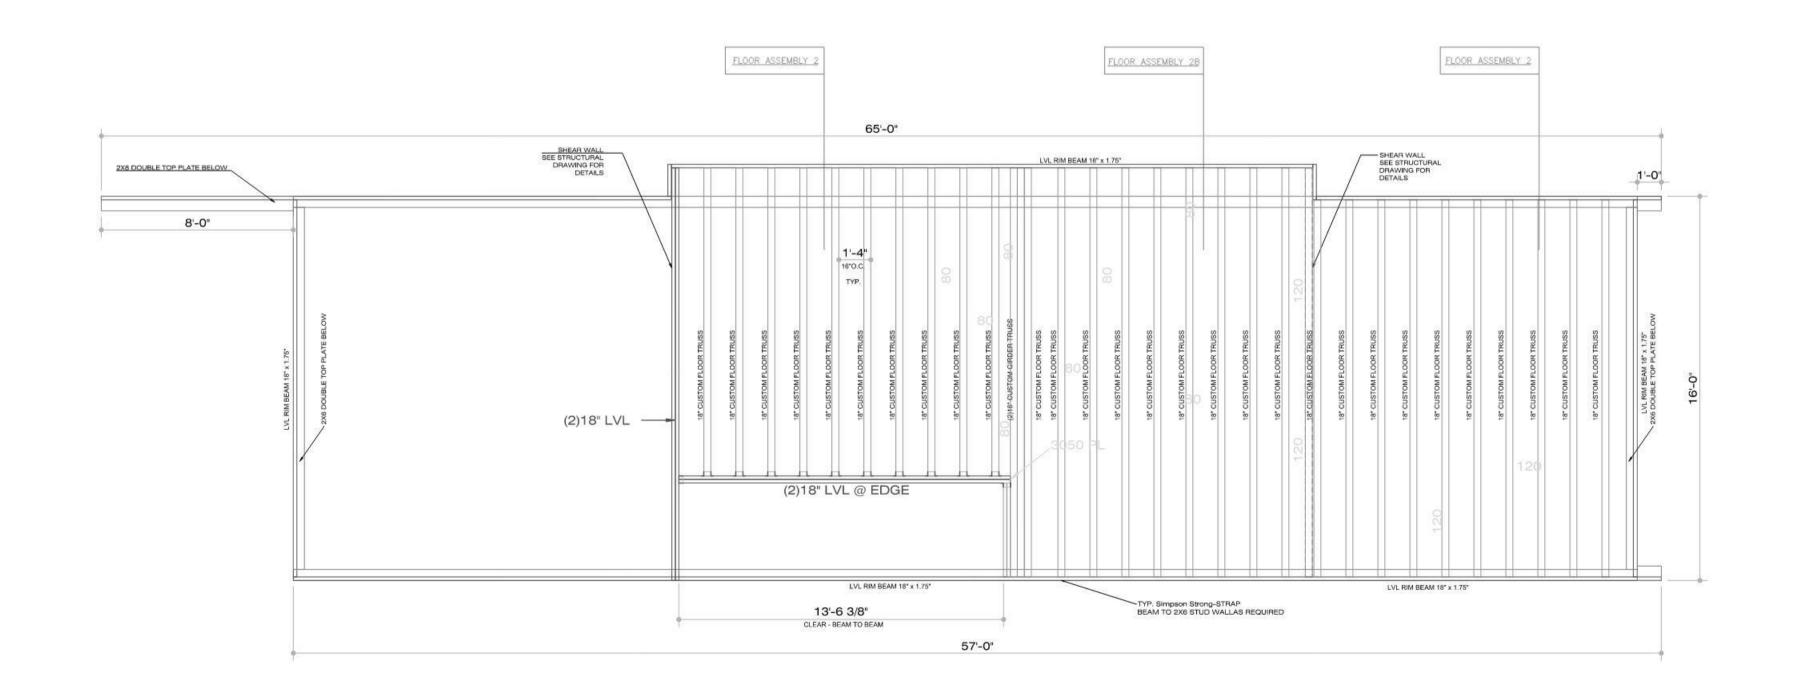

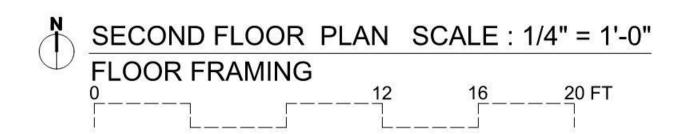

ARCHITECT, AIA 14520 Briar Forrest Drive #2308 Houston, Texas 77077 ARQUITECTURA3000@ATT.NET



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### PROJECT NAME:

### **4X4 ALL TERRAIN** SINGLE FAMILY RESIDENCE

PROJECT LOCATION: 4600 ROBERTSON STREET Houston, Texas 77009

#### OWNER: CITY OF HOUSTON HOUSING AND COMMUNITY DEVELOPMENT DEPT. 2100 TRAVIS STREET | 9TH FLOOR | HOUSTON TX 77002












COMMUNITY: A HOUSING AND URBAN DESIGN COMPETITION

DRAWING NAME: FRAMING PLANS

A-06 SHEET

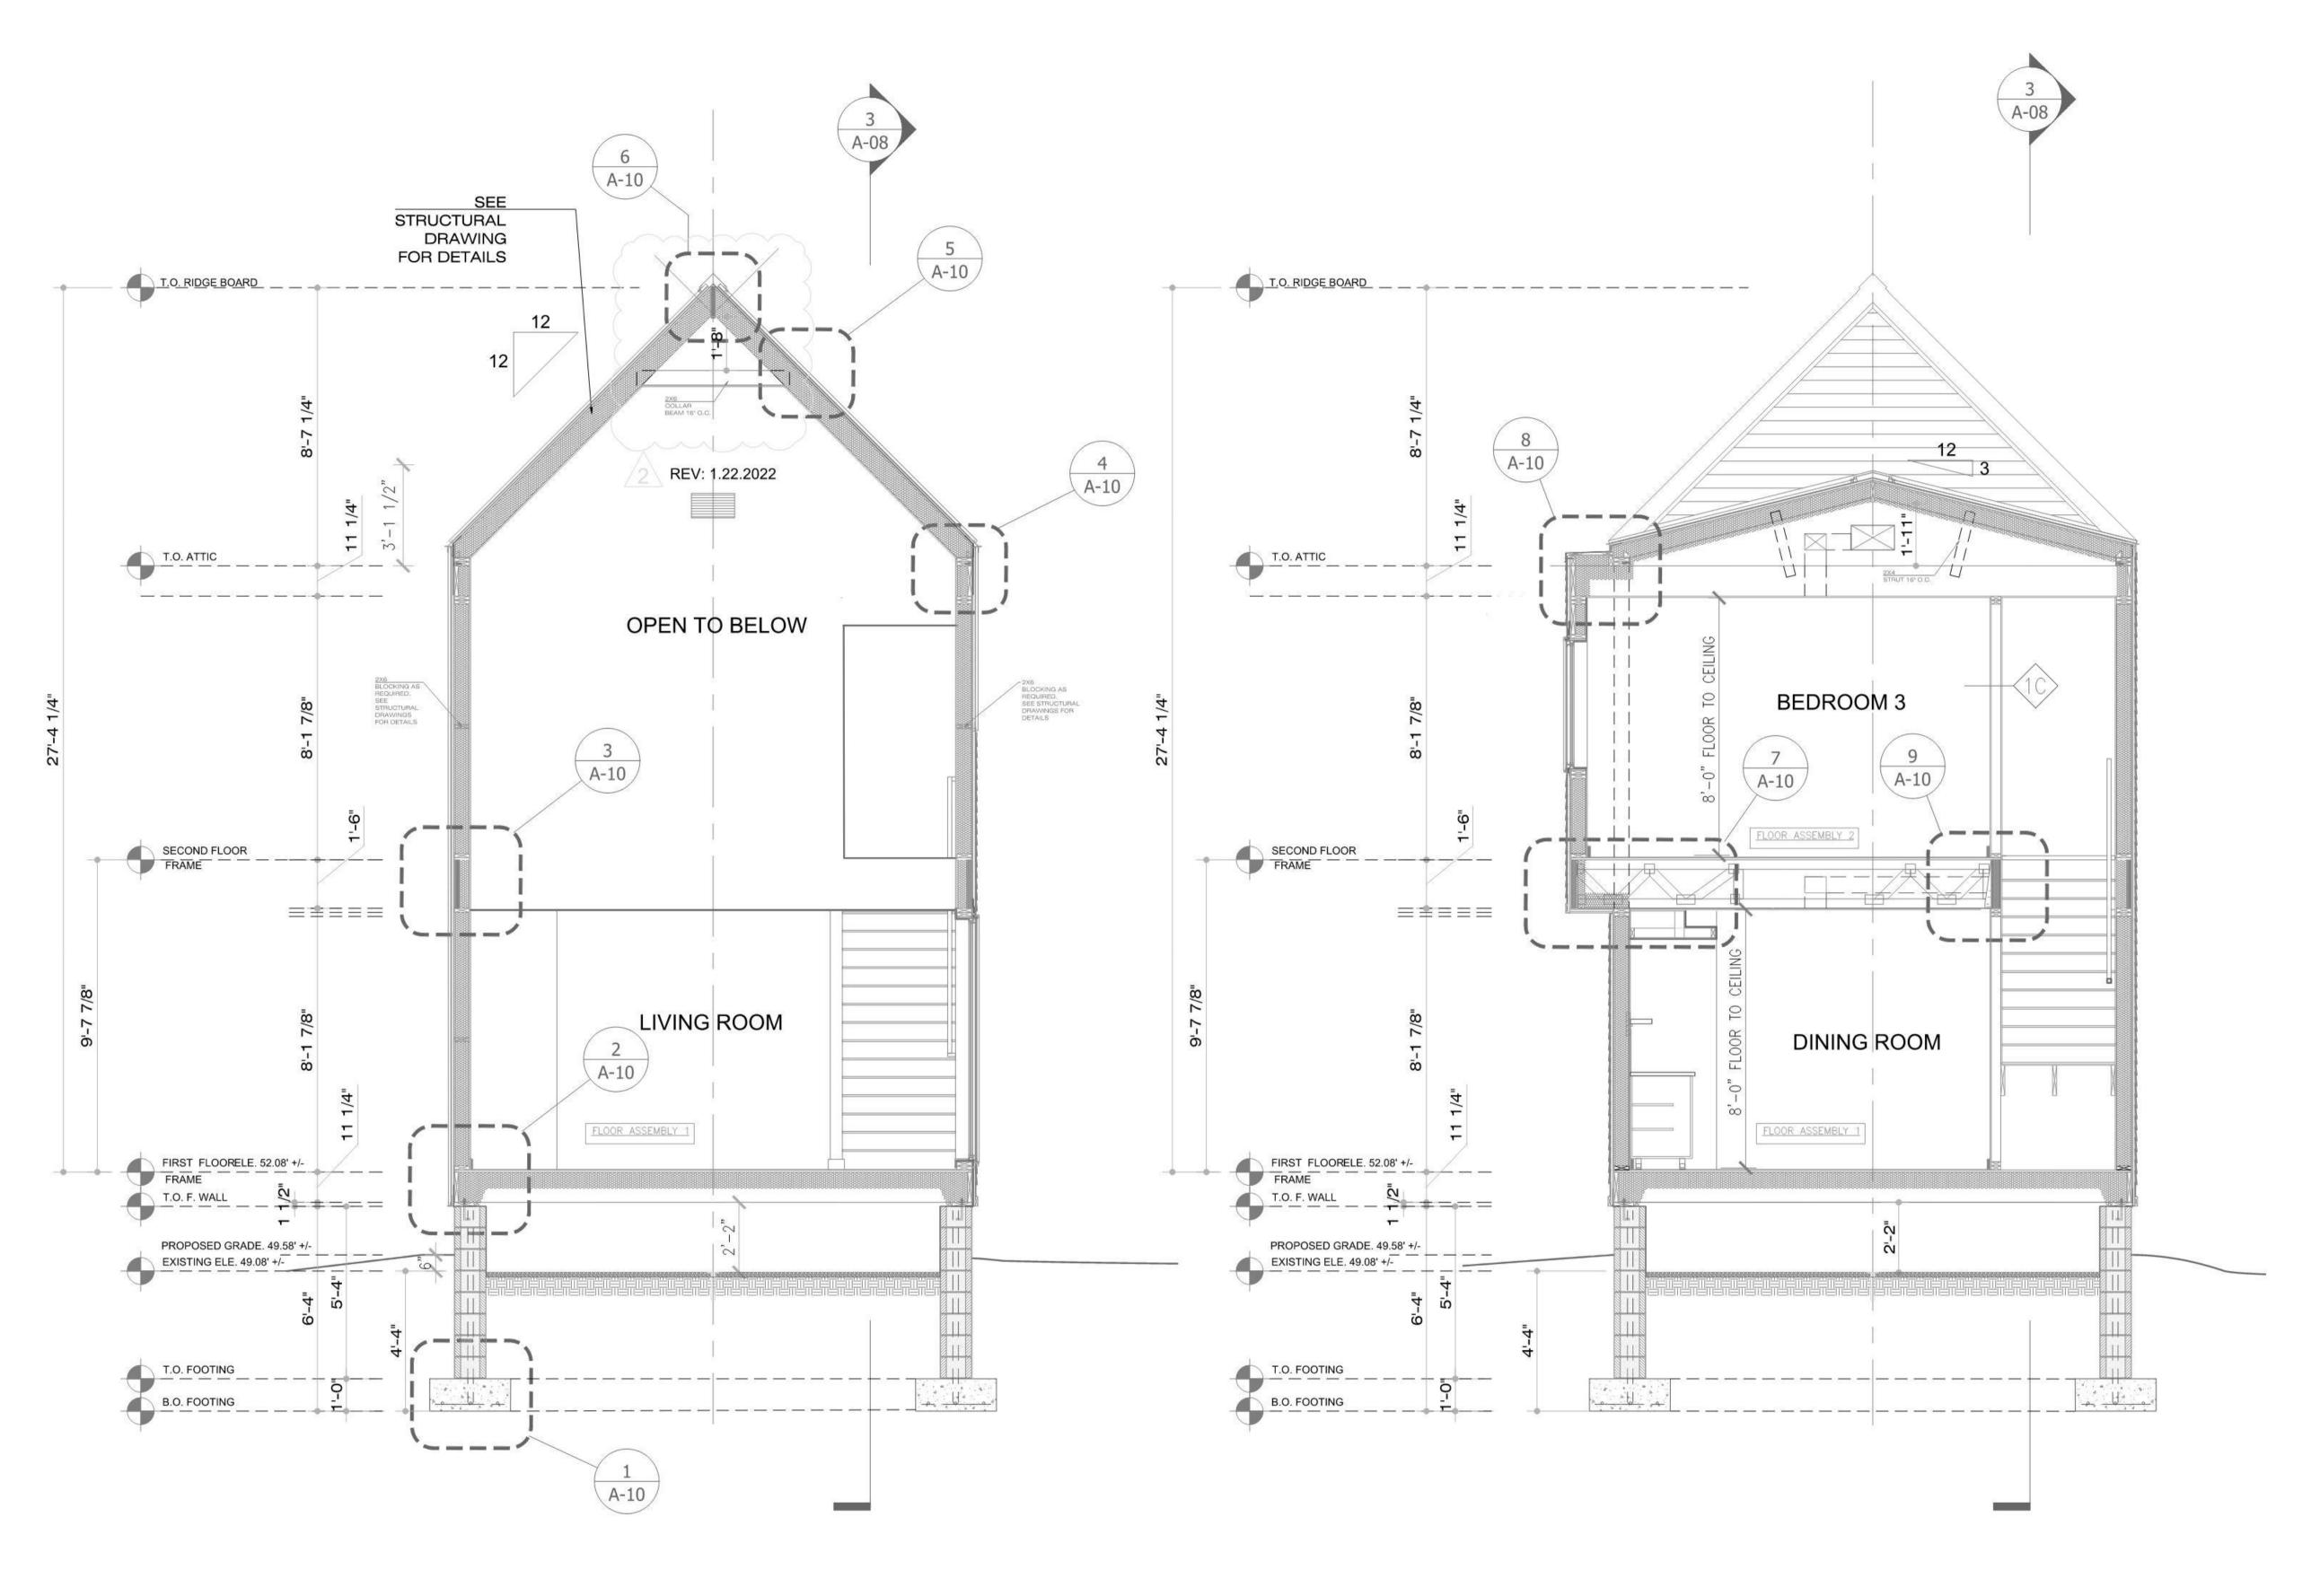

SCALE: 3/8" = 1'-0" SECTION 1. 20 FT

SCALE: 3/8" = 1'-0" SECTION 2. 20 FT

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PROJECT NAME:

### **4X4 ALL TERRAIN** SINGLE FAMILY RESIDENCE

PROJECT LOCATION: 4600 ROBERTSON STREET Houston, Texas 77009

# OWNER:

CITY OF HOUSTON HOUSING AND COMMUNITY DEVELOPMENT DEPT. 2100 TRAVIS STREET | 9TH FLOOR | HOUSTON TX 77002














DRAWING NAME: **SECTIONS** 

A-07 SHEET

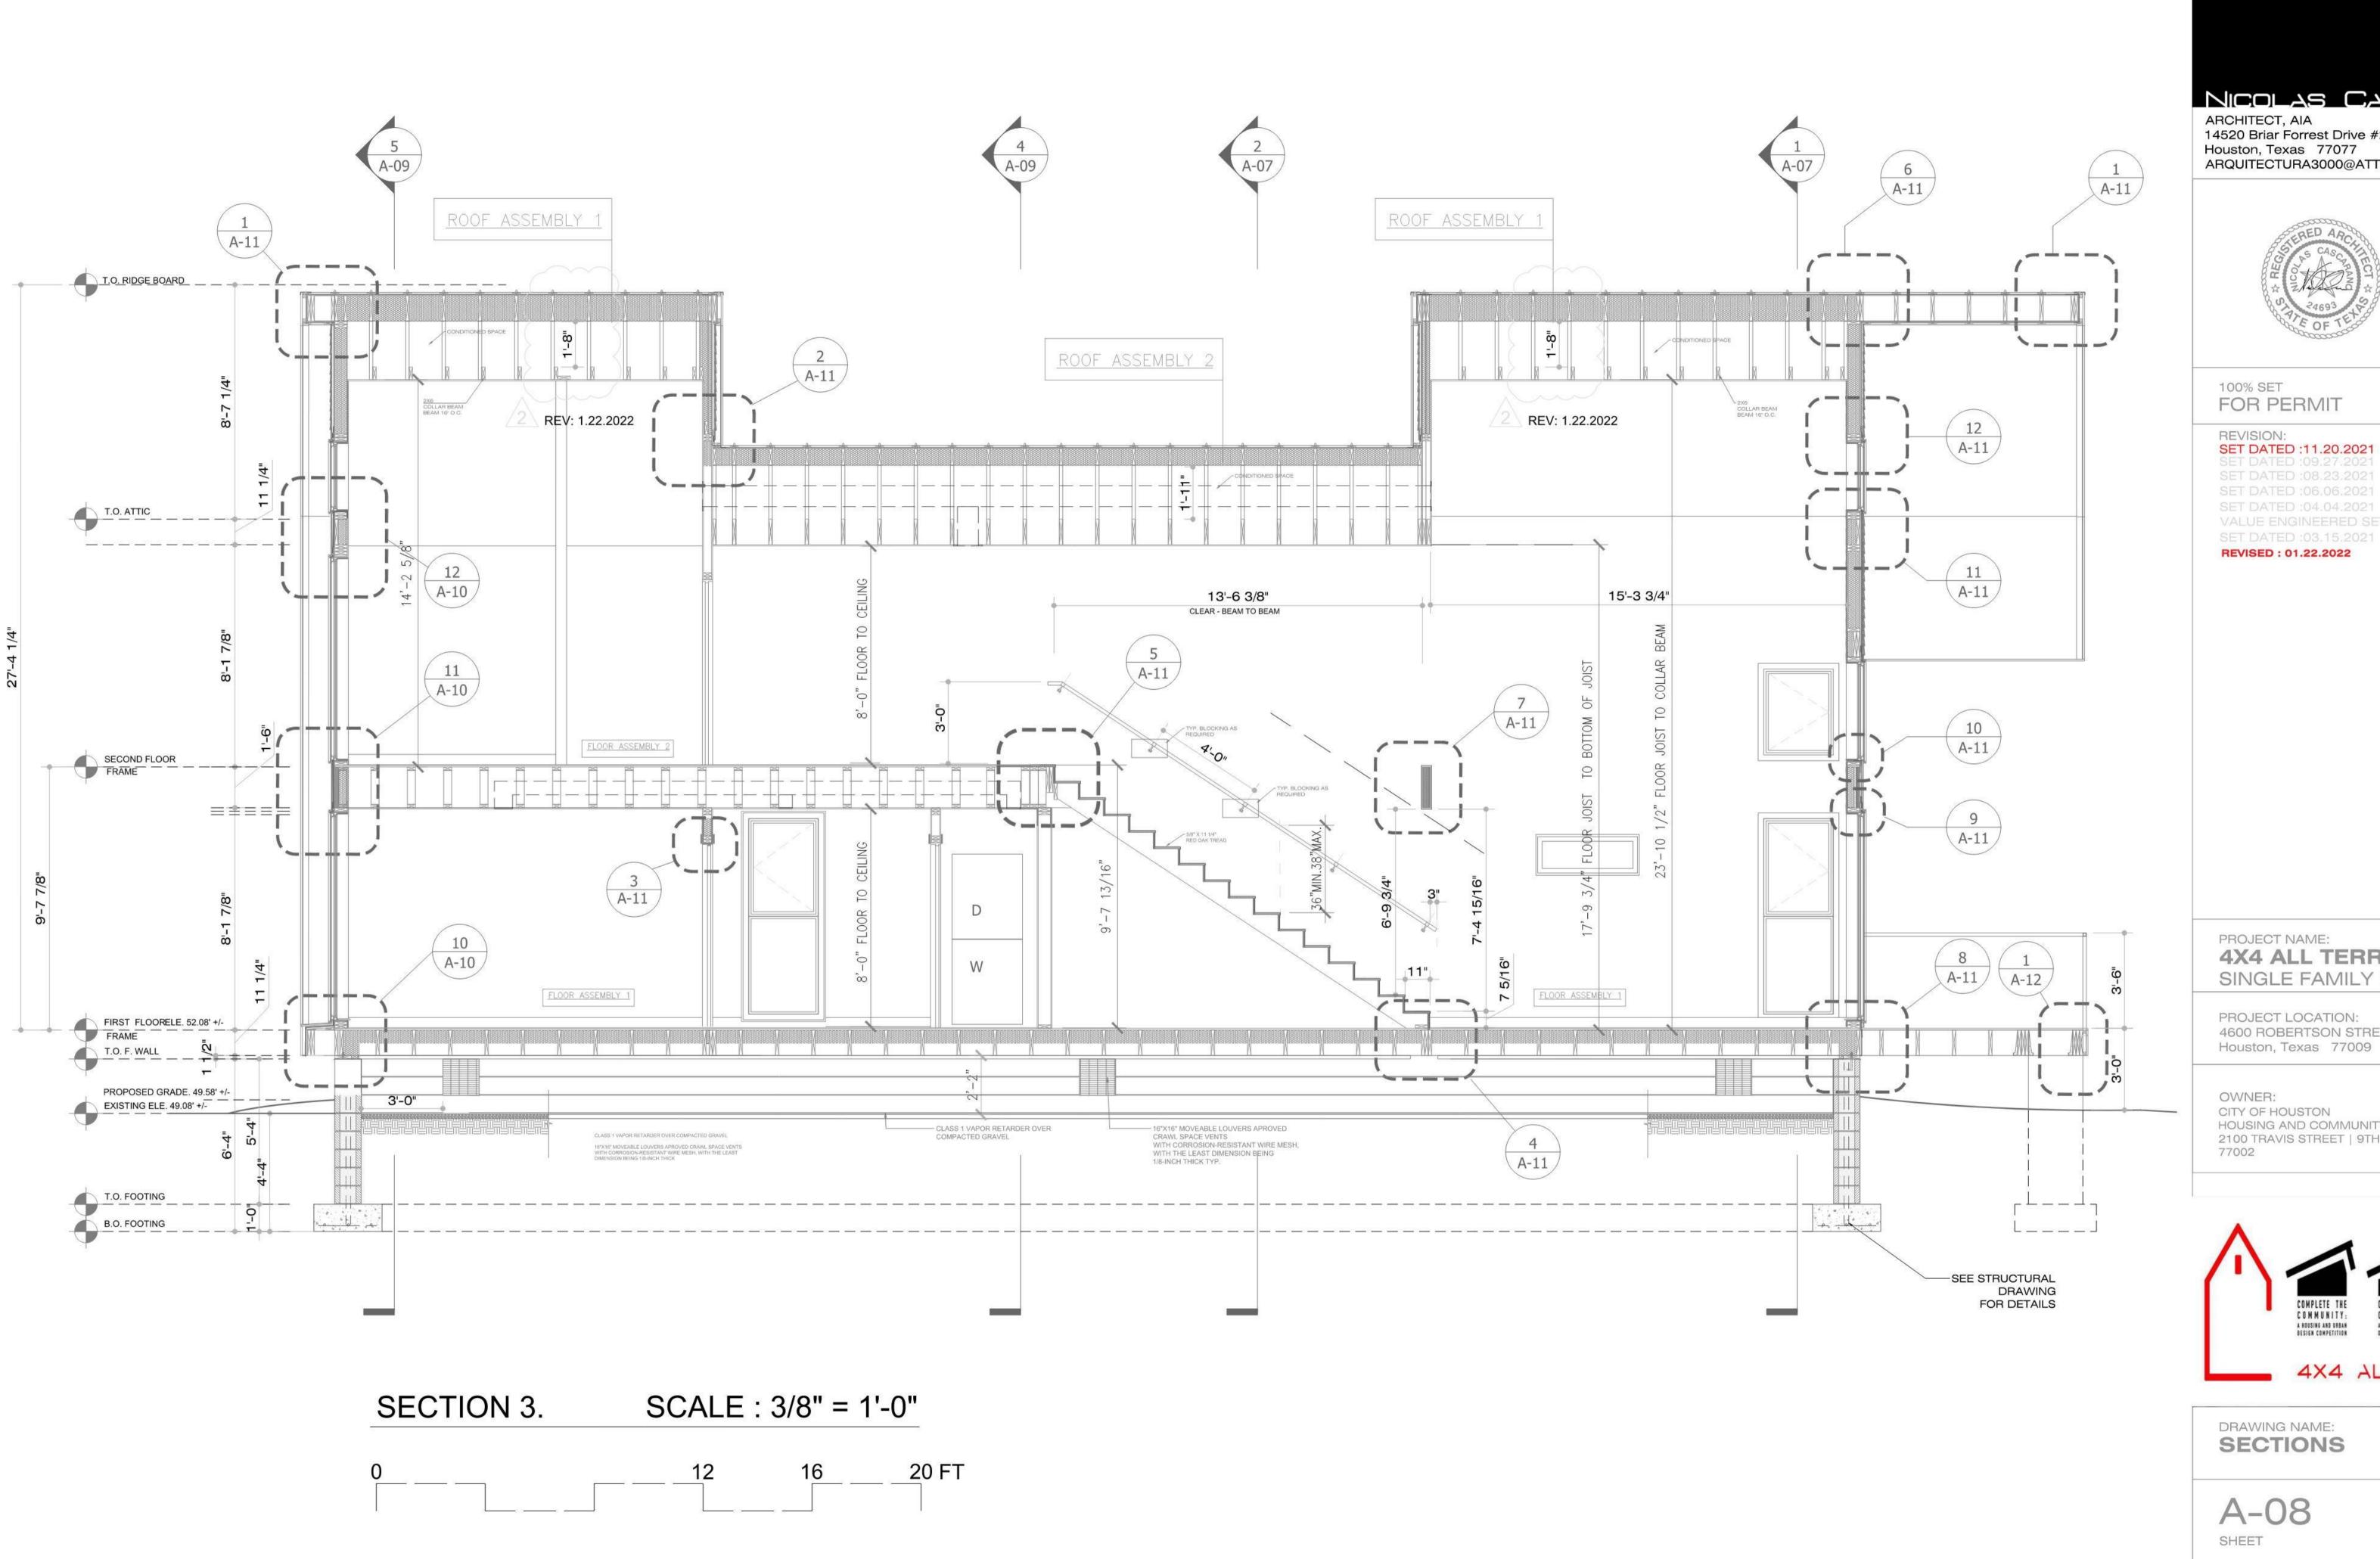

ARCHITECT, AIA 14520 Briar Forrest Drive #2308 Houston, Texas 77077 ARQUITECTURA3000@ATT.NET



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### **4X4 ALL TERRAIN** SINGLE FAMILY RESIDENCE

PROJECT LOCATION: 4600 ROBERTSON STREET Houston, Texas 77009

HOUSING AND COMMUNITY DEVELOPMENT DEPT.

2100 TRAVIS STREET | 9TH FLOOR | HOUSTON TX








4X4 ALL TERRAIN

DRAWING NAME: **SECTIONS** 

A-08

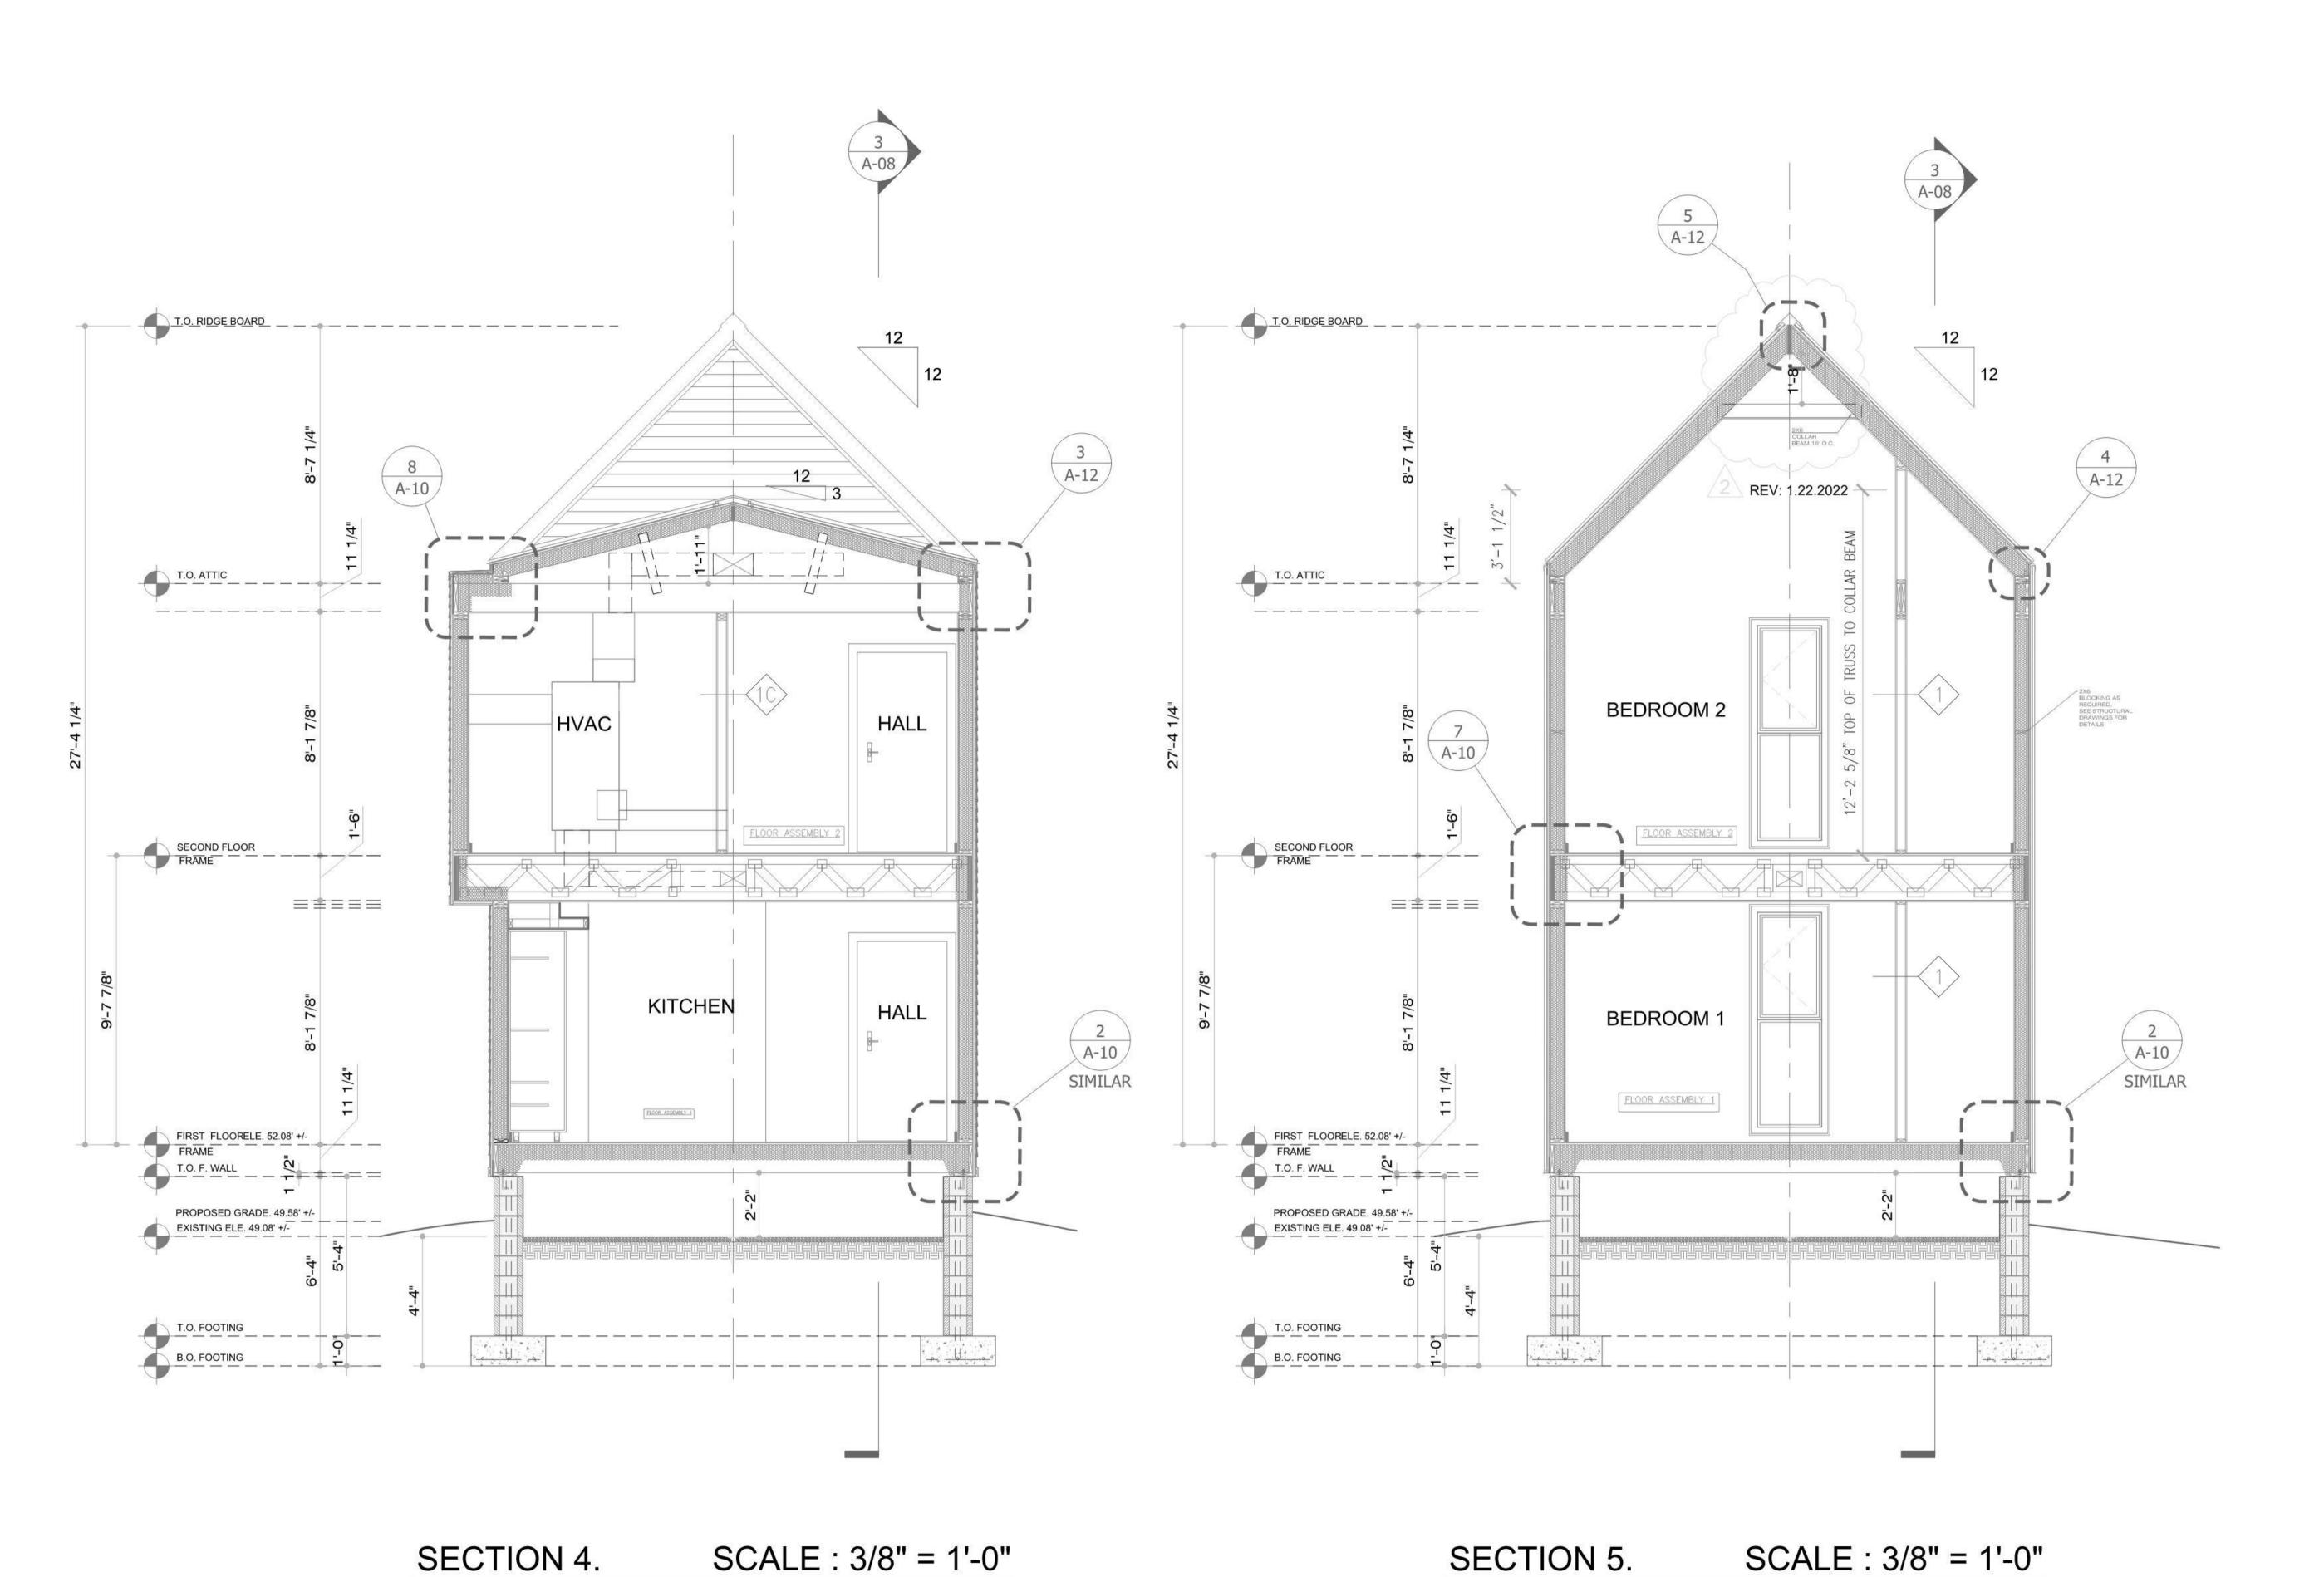

20 FT

NICOLAS CASCARANO

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PROJECT NAME:

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PROJECT LOCATION: 4600 ROBERTSON STREET Houston, Texas 77009


OWNER:

CITY OF HOUSTON HOUSING AND COMMUNITY DEVELOPMENT DEPT. 2100 TRAVIS STREET | 9TH FLOOR | HOUSTON TX 77002







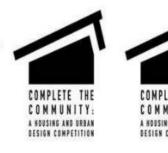



4X4 ALL TERRAIN


DRAWING NAME: **SECTIONS** 


A-09 SHEET

20 FT

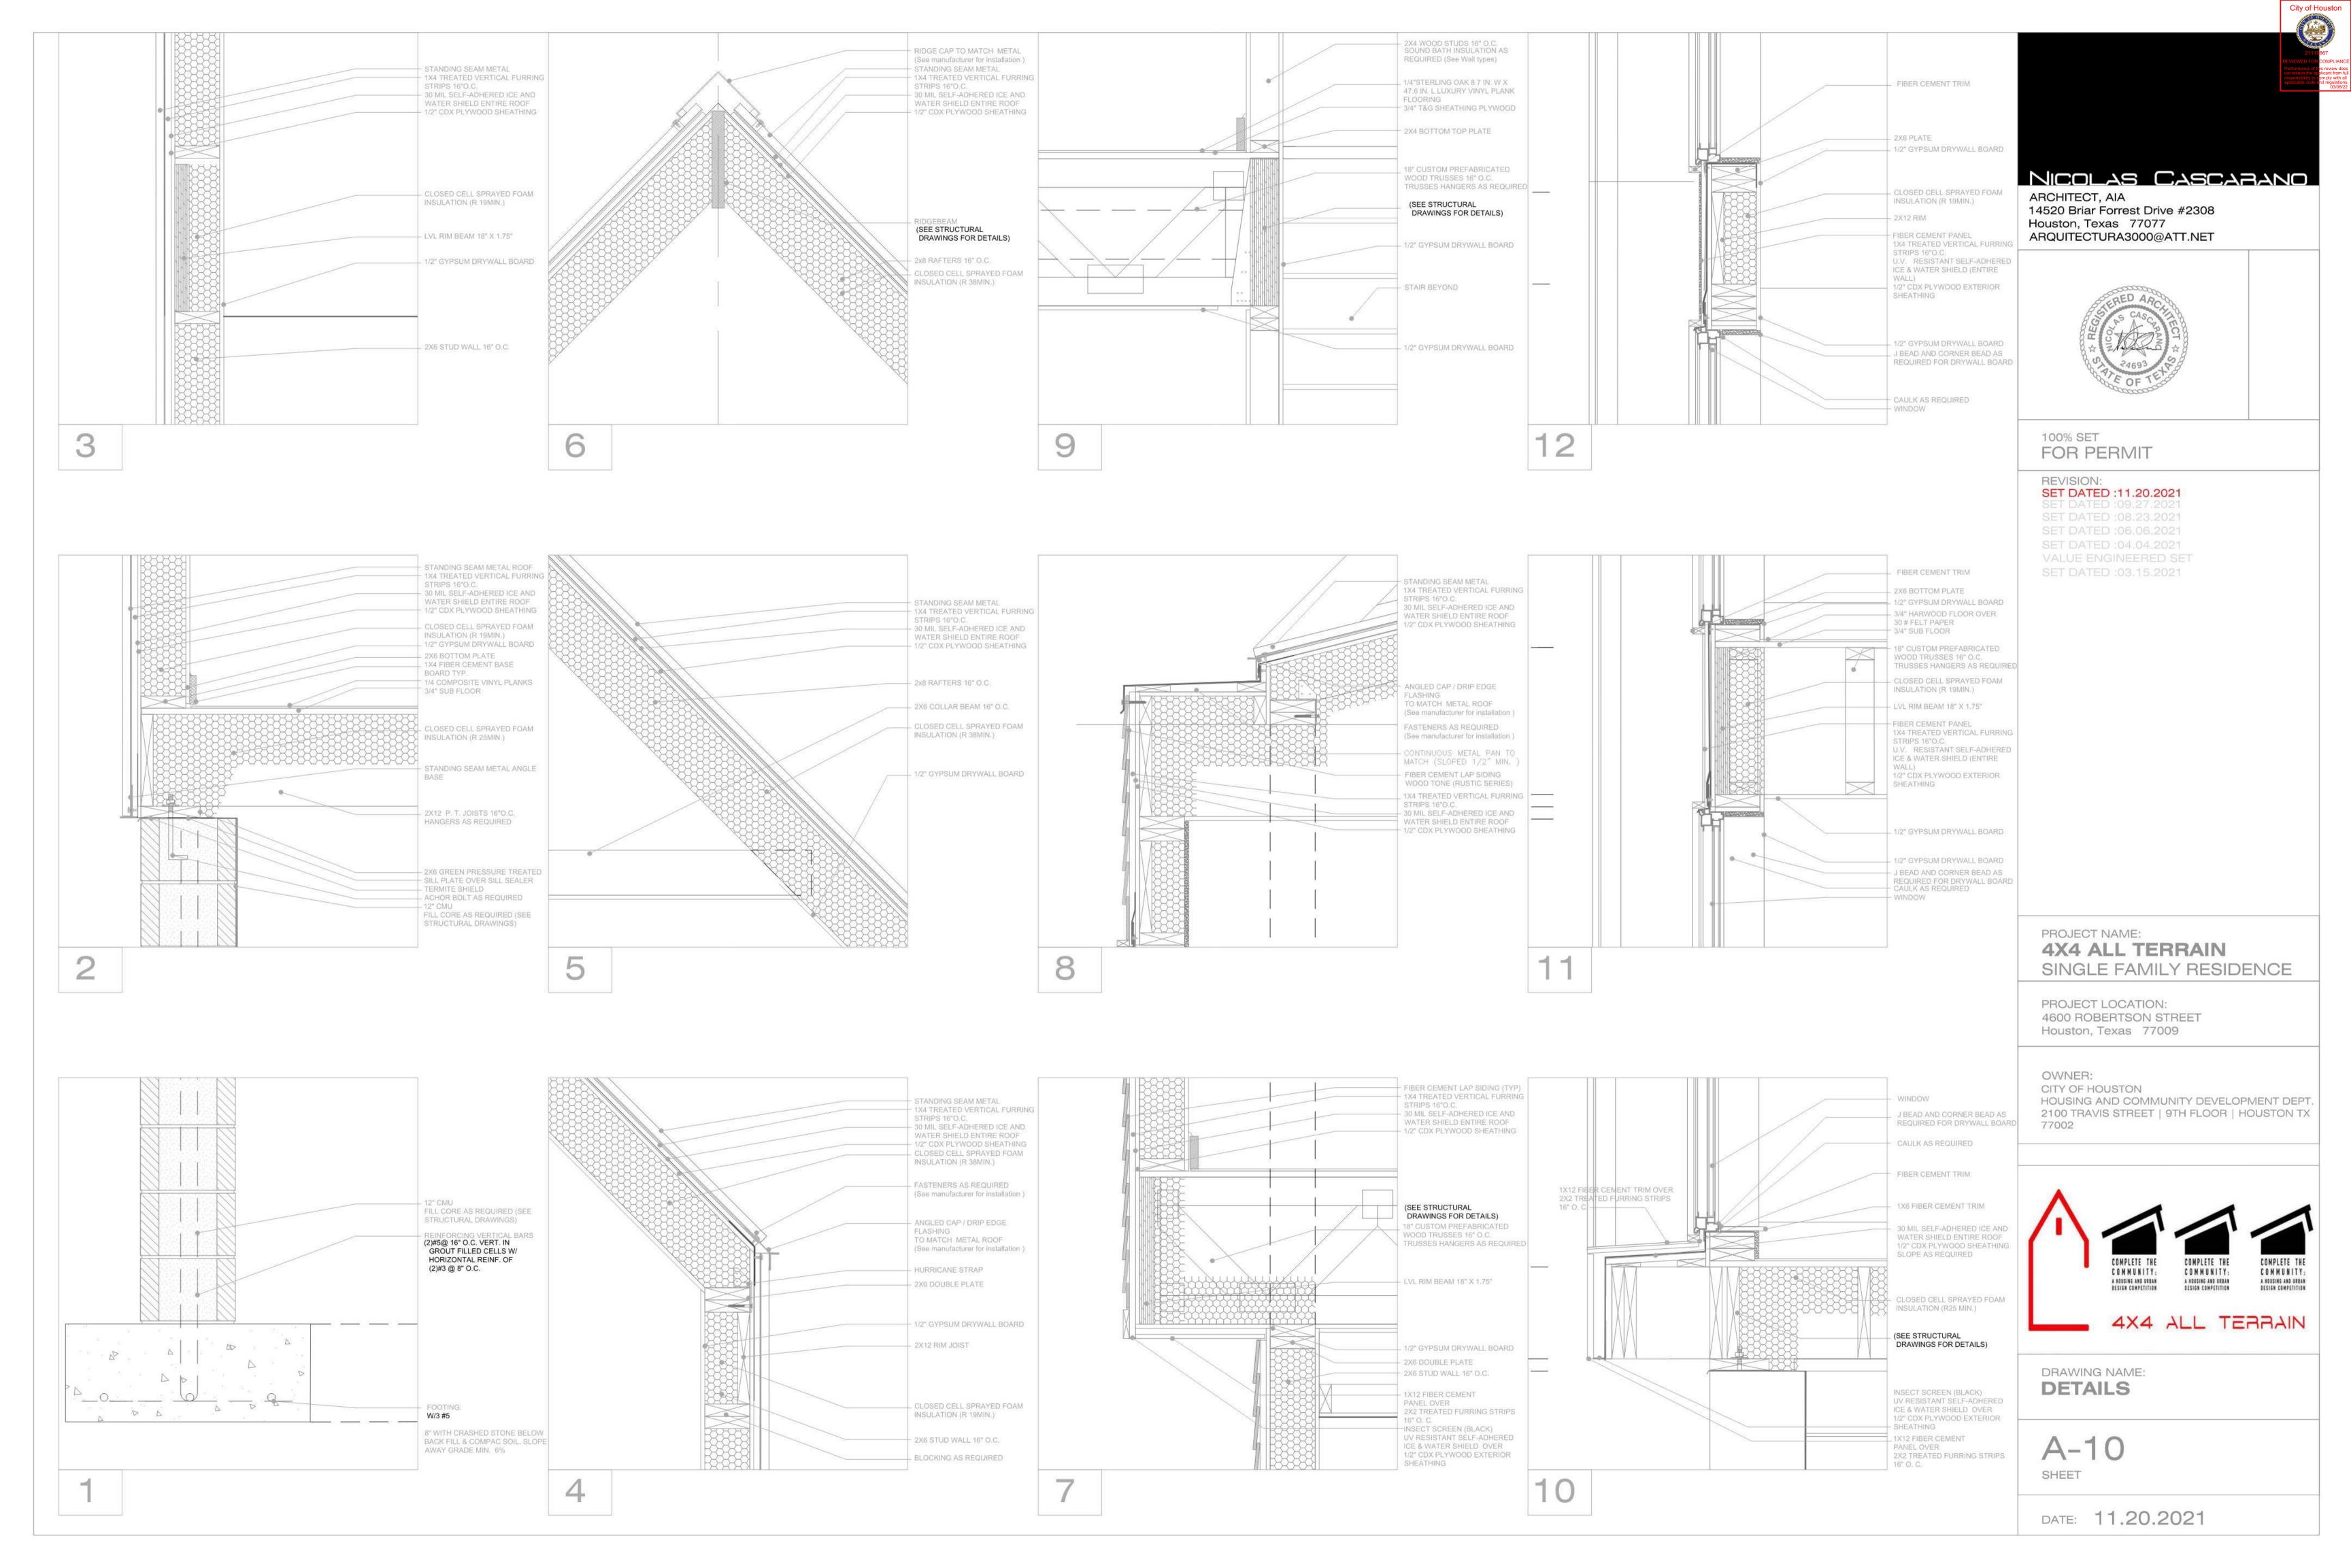

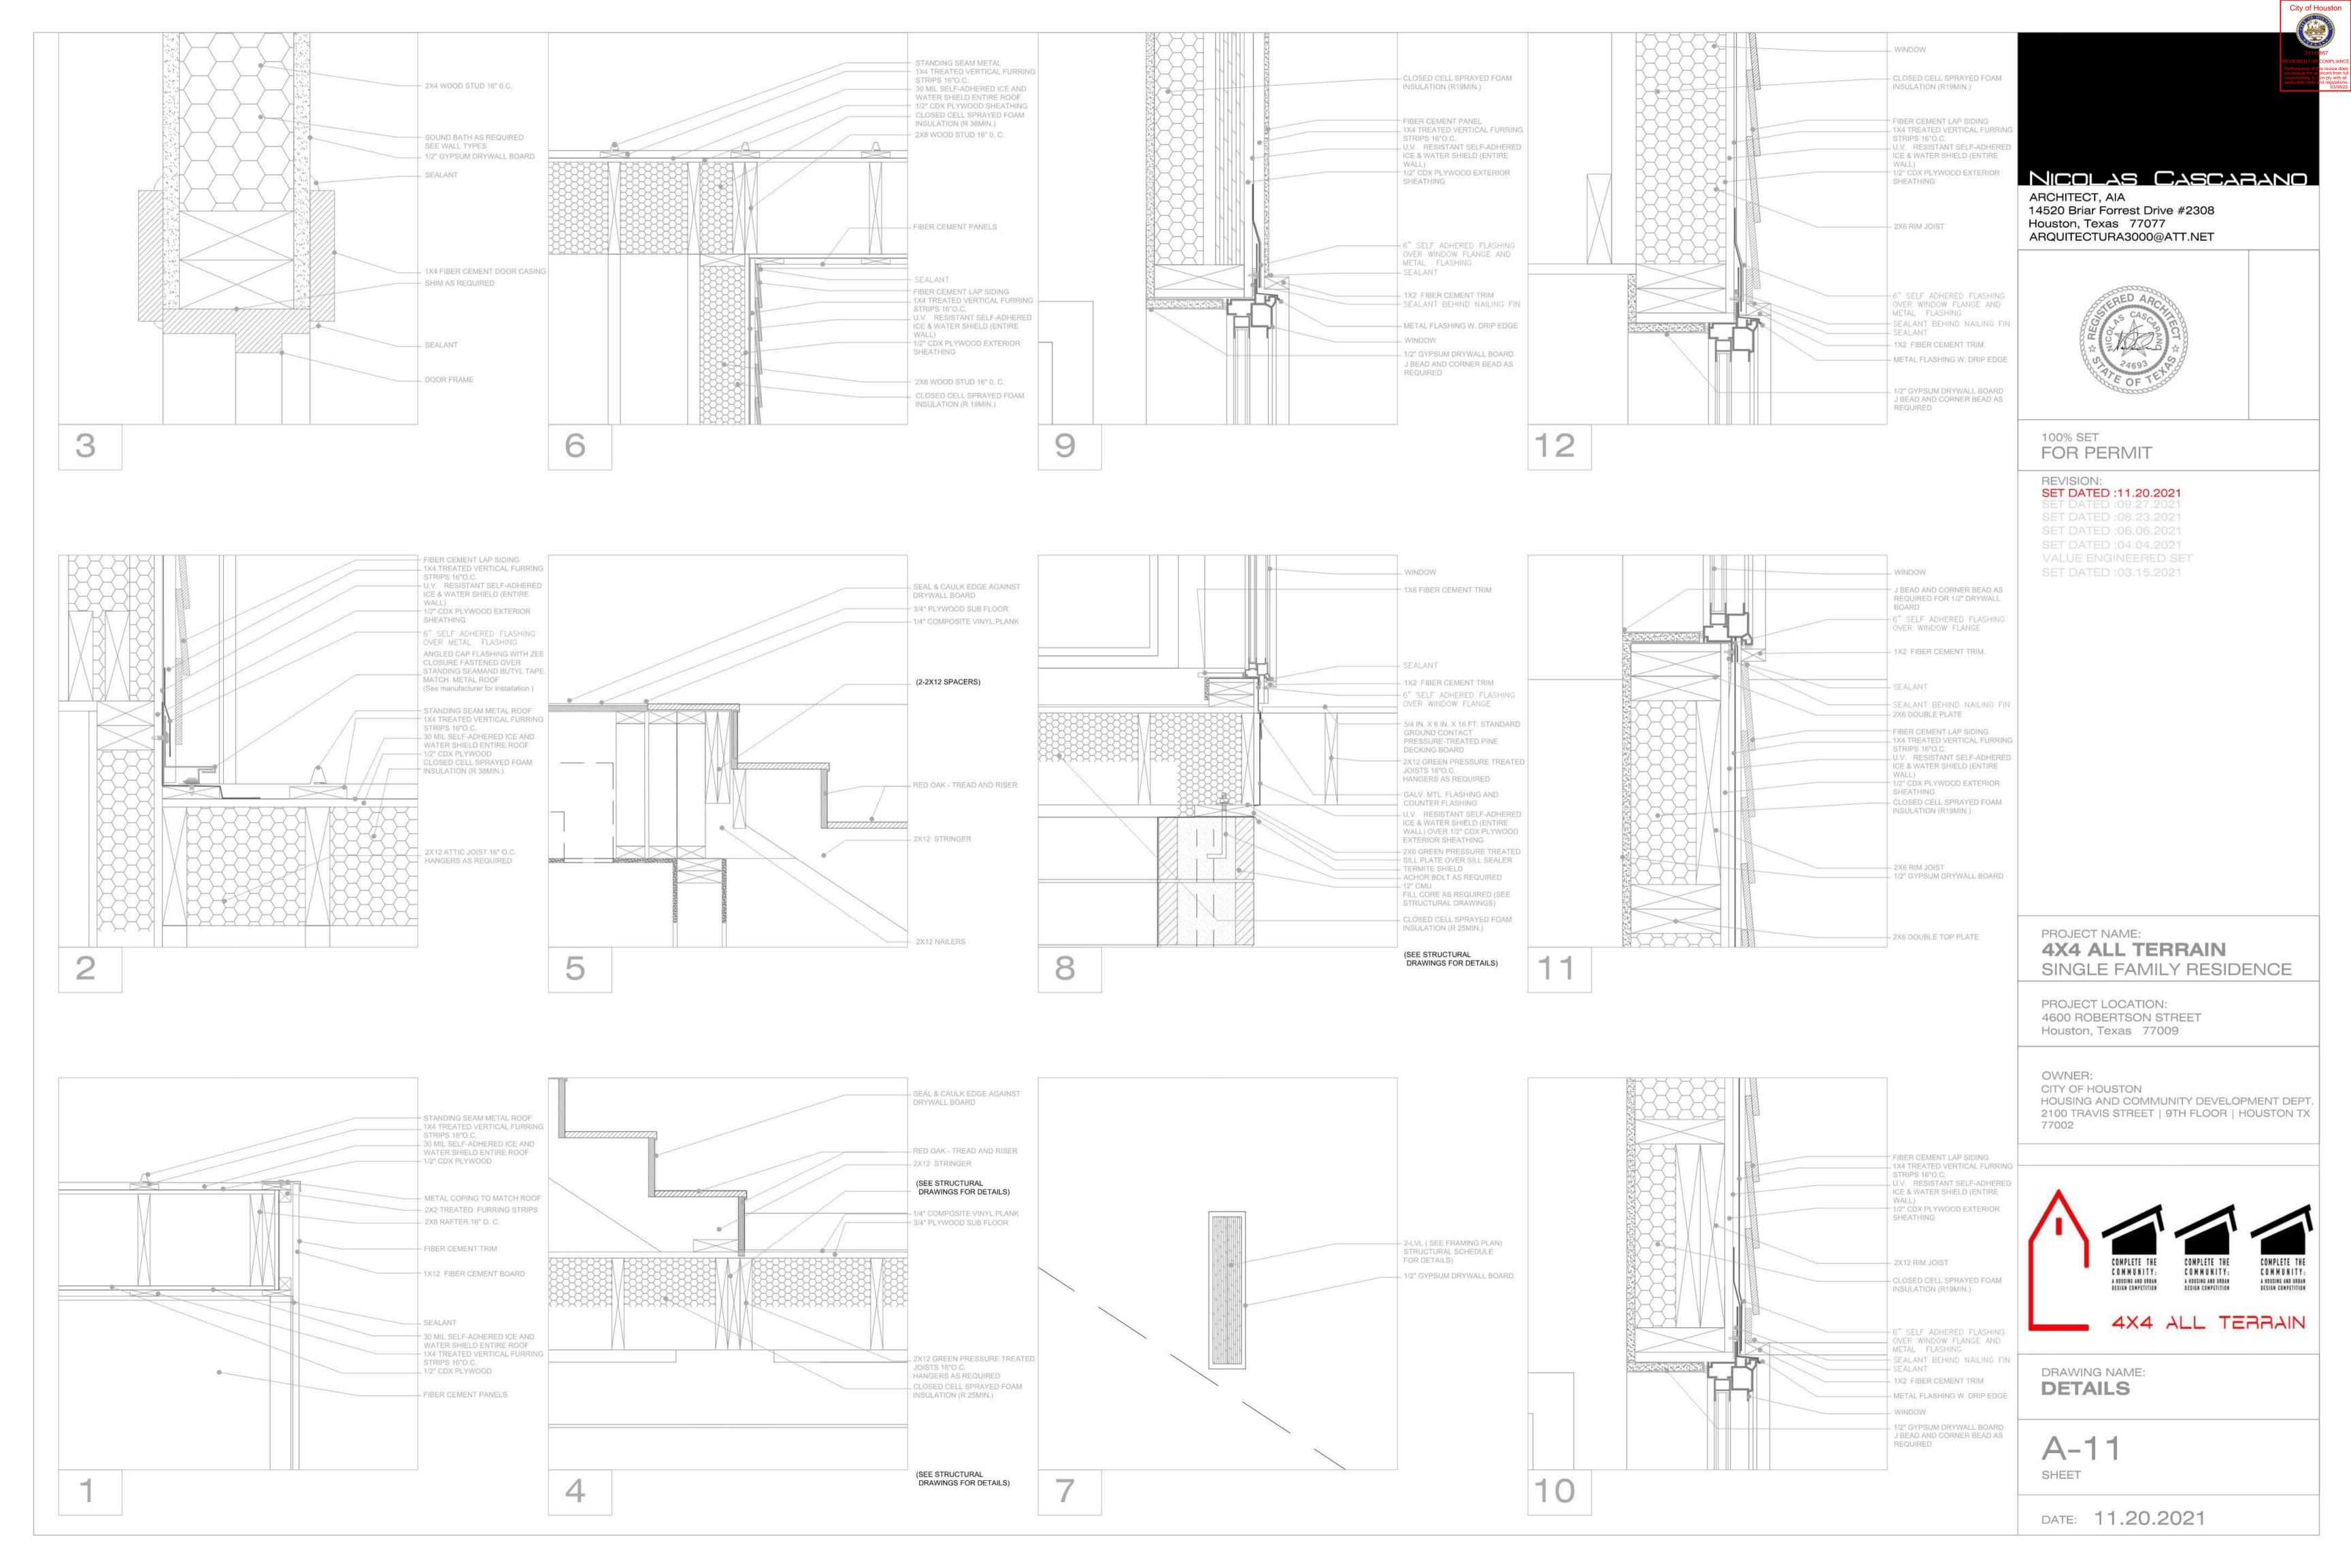

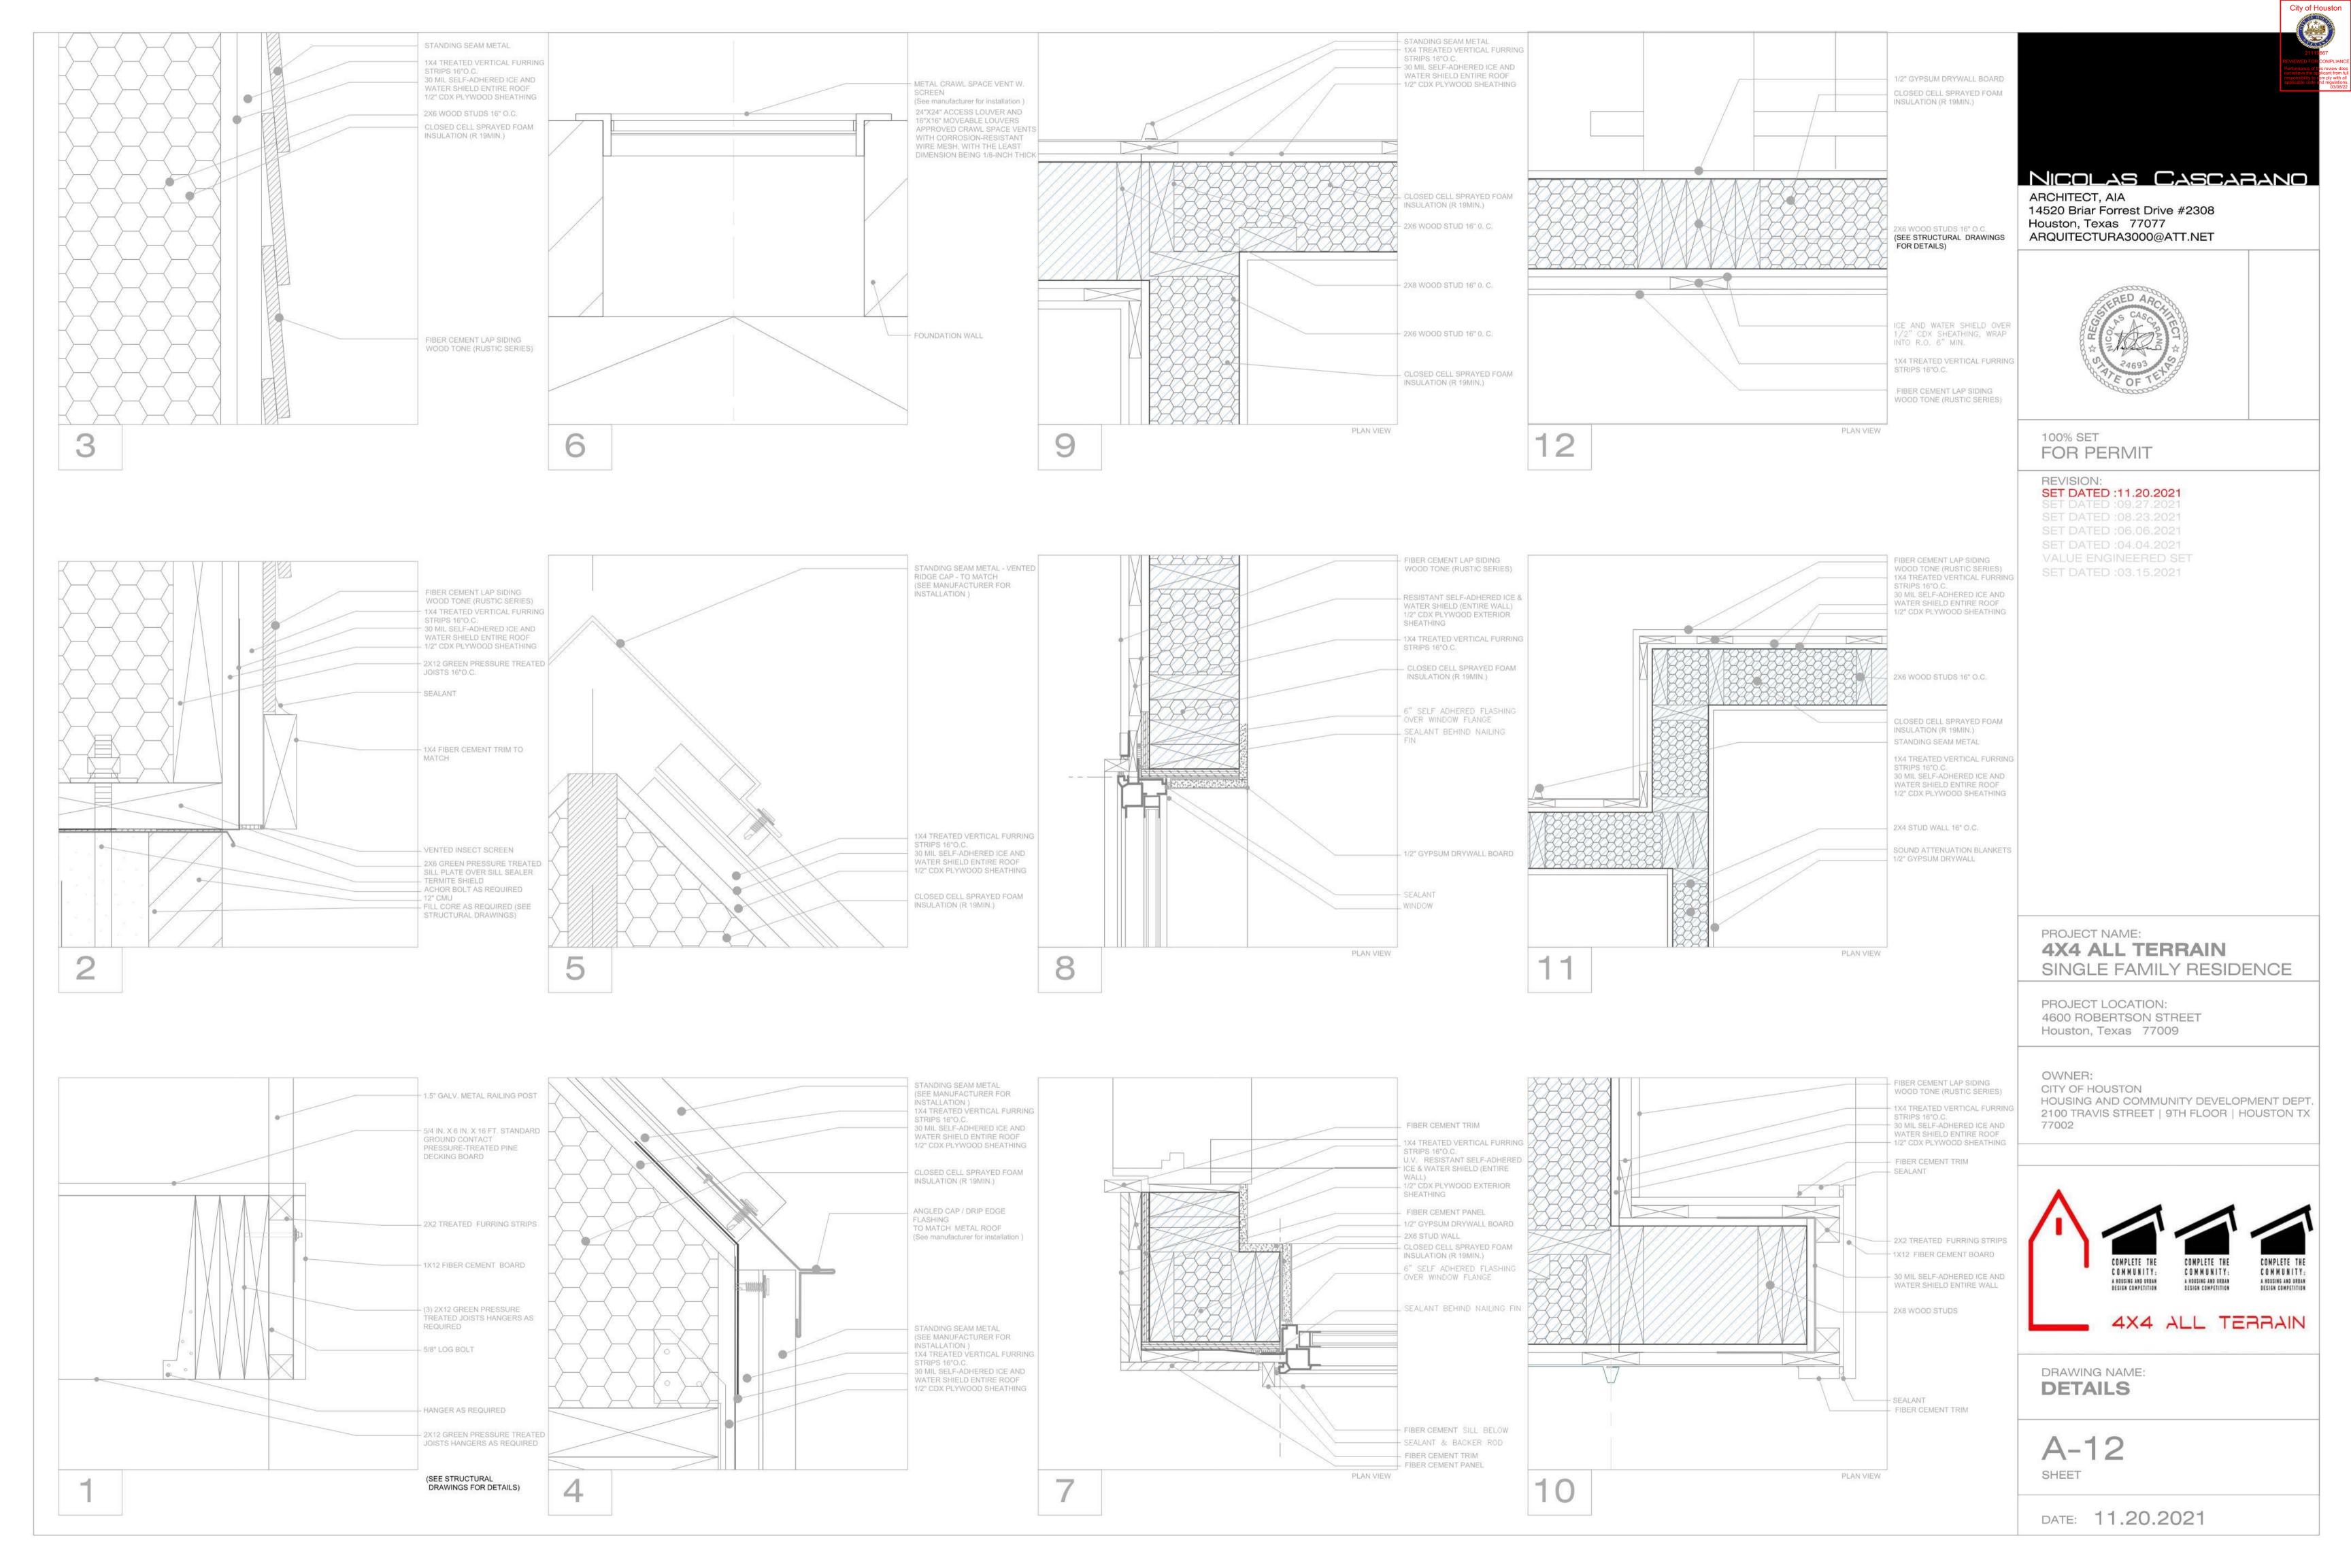

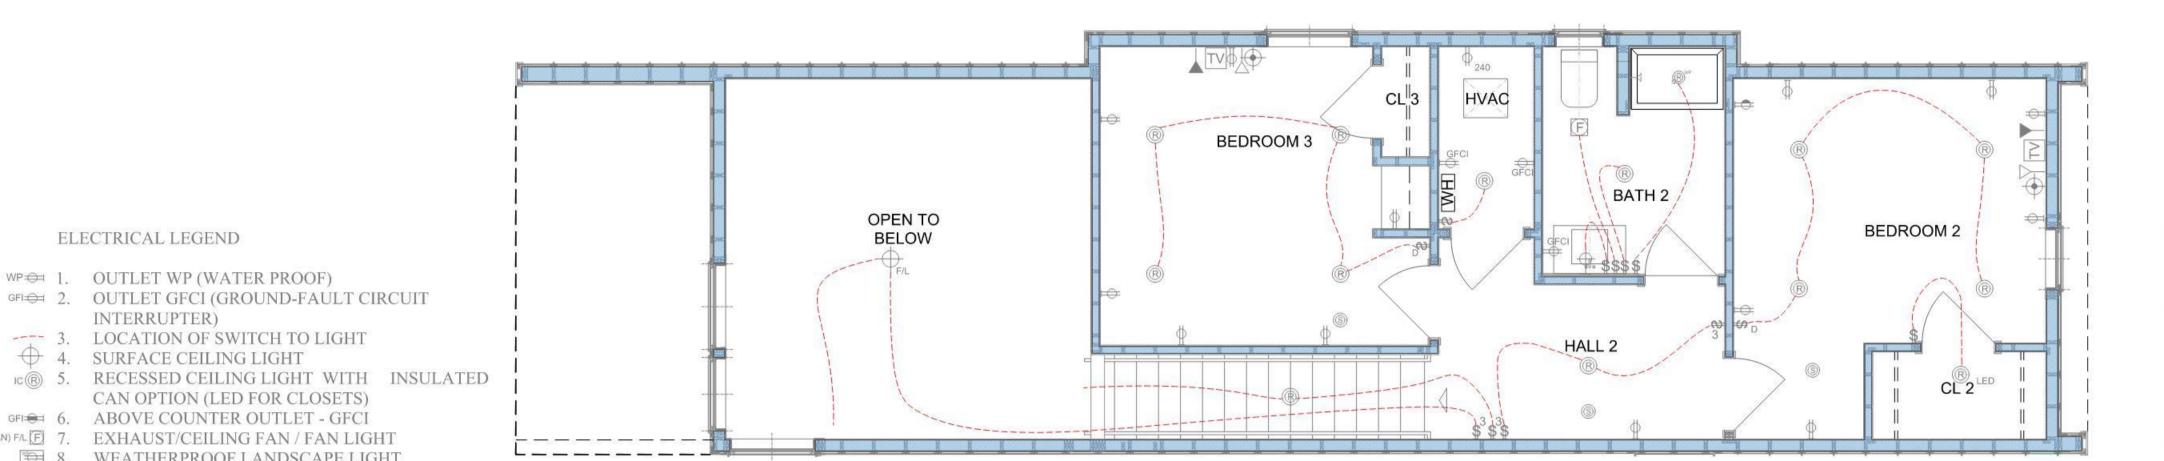

ELECTRICAL LEGEND

WP⇔ 1. OUTLET WP (WATER PROOF)

3. LOCATION OF SWITCH TO LIGHT

GFI 6. ABOVE COUNTER OUTLET - GFCI

8. WEATHERPROOF LANDSCAPE LIGHT

9. WALL MOUNTED LIGHT FIXTURE T 3

CAN OPTION (LED FOR CLOSETS)

→ 18. 110V DUPLEX OUTLET WITH UPPER LIVE

INTERRUPTER)

4. SURFACE CEILING LIGHT

(H/F HOOD FAN) F/L F 7. EXHAUST/CEILING FAN / FAN LIGHT

\* 11. SINGLE POLE SWITCH

T⇔ 14. SWITCH WITH TIMER D ← 15. SWITCH DIMMER

⇒ 17. 110V DUPLEX OUTLET

20. TELEPHONE OUTLET 21. COMPUTER DATA OUTLET

• 19. FLOOR MOUNT OUTLET

22. STEREO SPEAKER OUTLET

23. CABLE TELEVISION OUTLET CH

35. SMOKE DETECTOR / CARBOM MONXIDE

220/240 → 16. 240V OR 220V OUTLET

① 10. THERMOSTAT

3 € 12. 3-WAY SWITCH

<sup>4</sup> 13. 4-WAY SWITCH

▲ ▲ 32. TRACK LIGHT

======= 40. ROPE LIGHT

battery back-up

of one (1)

the central

room, All

instructions.

than solid

burns solid.

has a fuel

required and is to

appliances (e.g.,

manufacturer's instructions

on the main living area floor.

EACH STORY OF THE DWELLING.

WITH MANUFACTURER'S INSTRUCTIONS.

alarm/carbon

33. PENDANT LIGHT

FE 34. FIRE EXTINGUISHER

36. SERVICE ENTRANCE PANEL

38. 4 LAMP FLUORESCENT LIGHT

37. 2 LAMP FLUORESCENT LIGHT

====== 39. UNDER COUNTER FLUORESCENT LIGHT

Smoke Detectors: All smoke detectors shall be hard-wired with

smoke detector per floor (including the basement) and a smoke

located adjacent to all bedrooms/sleeping rooms and adjacent to

smoke detectors shall be installed per manufacturer's installation

liquid or gaseous fuels is located horizontally adjacent to any

hard-wired with battery back-up carbon monoxide detector is

source heating system (not electric), other solid fuel burning

monoxide detector is required to be installed per the

COMBINATION SMOKE & CARBON MONOXIDE DETECTORS:

DETECTORS SHALL BE INSTALLED OUTSIDE EACH SEPARATE


SLEEPING AREA IN THE IMMEDIATE VICINITY OF BEDROOMS AND ON

ALL DETECTORS SHALL BE CONNECTED TO THE MAIN PANEL AND A SOUNDING DEVICE OR OTHER DETECTORS TO PROVIDE AN ALARM AUDIBLE IN ALL SLEEPING AREAS. ALL DETECTORS SHALL BE APPROVED AND LISTED AND SHALL BE INSTALLED IN ACCORDANCE

electric), a hard-wired with battery back-up combination smoke

be installed per the manufacturer's instructions. Any dwelling that

and interconnected with all other alarms. There shall be a minimum

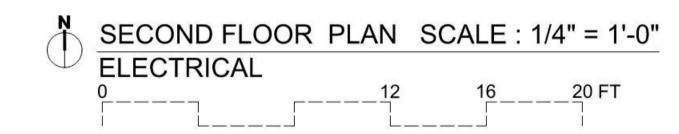

0 \_\_\_\_\_\_12 \_\_\_\_\_16 \_\_\_\_\_20 FT

IT SHALL BE THE CONTRACTOR'S RESPONSIBILITY TO LOOK THROUGH ALL DRAWINGS ASSOCIATED WITH THIS PROJECT. WORK ASSOCIATED WITH THE ELECTRICAL CONTRACTOR'S TRADE MAY BE SHOWN ON OTHER DRAWINGS. ANY ADDITIONAL COST RESULTING FROM THE FAILURE TO INCLUDE THESE ITEMS SHOWN ON THE OTHER DRAWINGS WILL BE INCURRED BY CONTRACTOR.

2. IT IS THE INTENT OF THESE DRAWINGS AND SPECIFICATIONS TO ESTABLISH A STANDARD OF QUALITY. THE CONTRACTOR SHALL BE RESPONSIBLE TO REQUEST THE ENGINEER WAIVE THE STANDARDS TO ALLOW ALTERNATE MEANS AND METHODS PRIOR TO BEGINNING THE PROJECT, CONTRACT DOCUMENT REVISIONS TO ACCOMMODATE INSTALLED CONDITIONS, WITHOUT PRIOR APPROVAL, WILL RESULT IN ADDITIONAL DESIGN CHARGES TO THE

3. ELECTRICAL WORK SHALL BE PERFORMED IN A WORKMANLIKE MANNER IN ACCORDANCE WITH THE IRC ELECTRICAL 2015

4. ALL WORK, MATERIALS AND EQUIPMENT SHALL CONFORM TO THE CURRENTLY ADOPTED EDITION OF ALL APPLICABLE NATIONAL, STATE AND CITY CODES AND ORDINANCES.

5. ALL ELECTRICAL SYSTEM COMPONENTS SHALL BE LISTED OR LABELED BY UL OR OTHER RECOGNIZED TESTING FACILITY AS ALLOWED BY AUTHORITY HAVING JURISDICTION.

6. WHERE AN APPARENT DISCREPANCY EXISTS BETWEEN THE REQUIREMENTS OF THE GENERAL NOTES AND INFORMATION PORTRAYED IN THE ELECTRICAL DRAWINGS, THE CONTRACTOR SHALL INCLUDE IN THE BID THE COST OF THE GREATER QUALITY OR

7. CONTRACTOR SHALL VISIT JOB SITE PRIOR TO BID AND VERIFY EXISTING CONDITIONS.

8. CONTRACTOR SHALL INCLUDE IN BASE BID ALL COSTS REQUIRED FOR PERMITS AND

9. CONTRACTOR SHALL VERIFY, WITH OWNER'S REPRESENTATIVE PRIOR TO SUBMITTING BID, ALLOWABLE WORKING HOURS, EMPLOYEE PARKING AREAS, MATERIAL DELIVERY, STORAGE REQUIREMENTS, DEMOLITION

AND REMOVAL OF CONSTRUCTION DEBRIS, AS WELL AS DAILY CLEAN UP REQUIREMENTS. COSTS IN BID FOR DUST BARRIERS, DUMPSTERS ETC. AS REQUIRED FOR THE DURATION OF

THE PROJECT. PERFORM ALL WORK AS DIRECTED BY OWNER'S REPRESENTATIVE AND

WITHOUT ADDITIONAL COST TO OWNER.

10. ALL ELECTRICAL SYSTEMS SHALL BE TESTED FOR PROPER OPERATION. IF TESTS SHOW THAT WORK IS DEFECTIVE, CONTRACTOR SHALL MAKE ALL NECESSARY CORRECTIONS AT NO ADDITIONAL COST TO OWNER 11. CONTRACTOR SHALL GUARANTEE ALL WORK AGAINST DEFECTS IN MATERIALS AND WORKMANSHIP WHICH MAY OCCUR UNDER NORMAL USE FOR A PERIOD OF ONE YEAR AFTER OWNER'S ACCEPTANCE. ALL DEFECTS SHALL BE PROMPTLY CORRECTED BY CONTRACTOR

11. DO NOT SCALE ELECTRICAL DRAWINGS. VERIFY EXACT LOCATION OF ALL DEVICES, JUNCTION BOXES. LIGHTING FIXTURES, ETC. WITH ARCHITECTURAL AND INTERIOR DESIGN DRAWINGS PRIOR TO

INSTALLATION. CONTRACTOR SHALL VERIFY THE EXACT LOCATION OF ALL MECHANICAL EQUIPMENT AND OTHER EQUIPMENT REQUIRING ELECTRICAL CONNECTION PRIOR TO ROUGH-IN. EVERY OUTLET HEIGHT SHALL BE VERIFIED ON EACH WALL WITH THE INTERIOR PLANNING AND DESIGN DRAWINGS. COORDINATE WITH CABINET SHOP DRAWINGS TO ENSURE PROPER HEIGHT AND LOCATION WITH RESPECT TO MILLWORK, EQUIPMENT, ETC.

12. THESE DRAWINGS INDICATE THE FINISHED REQUIREMENTS FOR THE ELECTRICAL SYSTEMS, EQUIPMENT. IGHTING FIXTURES, OUTLIFTS AND DEVICES, DUE TO STRUCTURAL CONDITIONS, MECHANICAL

CONFLICTS, OR OTHER LEGITIMATE REASONS, THE CONTRACTOR MAY DESIRE TO INSTALL THE WORK INDICATED IN A MANNER DIFFERENT FROM THAT SHOWN.

15. ANY VARIANCE OR EXCEPTIONS THE THE DRAWINGS AND SPECIFICATIONS MUST BE REQUESTED AND APPROVED IN WRITING BY THE OWNE/ARCHITECT, WHERE UNAUTHORIZED CHANGES ARE FOUND, THE CONTRACTOR SHALL REMOVE THE INSTALLED WORK AND INSTALL ITS AS SHOWN ON THE DRAWINGS AT NO ADDITIONAL COST THE THE OWNER. COST SHALL INCLUDE ANY CUTTING, PATCHING, PAINTING AND REPAIR COST TO INSTALLED CEILINGS, WALLS ETC. AS REQUIRED FOR CORRECTING THE DEFICIENCY.

16. PRIOR TO INSTALLATION, CONTRACTOR SHALL REVIEW THE COMPLETE SET OF CONSTRUCTION DOCUMENTS FOR CONFLICTS WITH OTHER TRADES, CONTRACTOR SHALL BE RESPONSIBLE TO COORDINATE ALL WORK WITH OTHER TRADES TO AVOID CONFLICT DURING INSTALLATION. CONTRACTOR SHALL MAKE MINOR ADJUSTMENTS IN EQUIPMENT LOCATION AND ROUTING AS NECESSARY AT NO ADDITIONAL COST TO THE OWNER.

18. COORDINATE ELECTRICAL REQUIREMENTS FOR ALL PLUMBING AND MECHANICAL EQUIPMENT WITH FINAL CONTRACTOR SELECTION.

19. THE ELECTRICAL CONTRACTOR PRIOR TO ROUGH-IN, SHALL VERIFY ALL HVAC AMPERAGES, PHASES AND VOLTAGES AGAINST PLAN REQUIREMENTS AND NOTIFY ENGINEER/ARCHITECT OF ANY DISCREPANCIES. FAILURE TO VERIFY AND NOTIFY ENGINNER/ARCHITECT PRIOR TO ROUGH-IN SHALL RESULT IN THE ELECTRICAL CONTRACTOR ASSUMING RESPONSIBILITY FOR DESIGN AND INSTALLATION REQUIREMENTS.

20. THE ELECTRICAL CONTRACTOR SHALL INSURE FINAL COORDINATION OF THE MANUFACTURERS RECOMMENDED FUSE SIZES FOR THE INSTALLED MECHANICAL EQUIPMENT WITH THE SIZE DISCONNECT PRIOR TO OR DURING ROUGH-IN. ADVISE ENGINEER IF CHANGES IN THE FINAL SELECTION OF MECHANICAL EQUIPMENT HAVE IMPACTED DISCONNECT SWITCH, BREAKER, OR CONDUCTOR SIZES.

21. VERIFY DEVICE COLOR AND MOUNTING ORIENTATION (VERTICAL OR HORIZONTAL) WITH ARCHITECT. 22. THE ELECTRICAL CONTRACTOR ASSUMES ALL RESPONSIBILITY AND LIABILITY FOR ANY

"VALUE ENGINEERING" OF THE MATERIALS, SPECIFICATIONS AND DESIGN OF THIS PROJECT, INCLUDING ANY AND ALL COST FOR ANY REVISIONS TO THE CONTRACT DOCUMENTS REQUIRED AS A RESULT IF THE "VALUE ENGINEERING". 23. PROPOSED ALTERNATE LIGHT FIXTURES SHALL BE SUBMITTED WITH A PHOTOMETRIC STUDY

SHOWING COMPLIANCE WITH ALL APPLICABLE LIGHTING CODES AND ORDINANCES. 42. AFTER COMPLETION OF THE INSTALLATION, THE ENTIRE ELECTRICAL SYSTEM SHALL BE THOROUGHLY CLEANED. REMOVE ALL FOREIGN MATERIAL, DUST, PAINT, OIL GREASE, UNNEEDED LABELS AND STICKERS FROM EQUIPMENTS. REMOVE ALL DEBRIS ACCUMULATED DURING CONSTRUCTION. 43. ALL 120V AND 277V DEVICES SHALL HAVE A DEDICATED NEUTRAL.

ELECTRICAL CONTRACTOR TO INSTALL A LIGHTNING ROD PROTECTION SYSTEM.

# NICOLAS CASCARANO

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#### 100% SET FOR PERMIT

#### REVISION:

SET DATED:11.20.2021 SET DATED:03.15.2021

PROJECT NAME:

### **4X4 ALL TERRAIN** SINGLE FAMILY RESIDENCE

PROJECT LOCATION: 4600 ROBERTSON STREET Houston, Texas 77009

OWNER:

CITY OF HOUSTON HOUSING AND COMMUNITY DEVELOPMENT DEPT. 2100 TRAVIS STREET | 9TH FLOOR | HOUSTON TX 77002










A HOUSING AND URBAN

4X4 ALL TERRAIN


DRAWING NAME: FLOOR PLANS **ELECTRICAL LAYOUT** 


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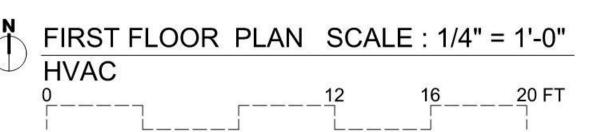
SHEET



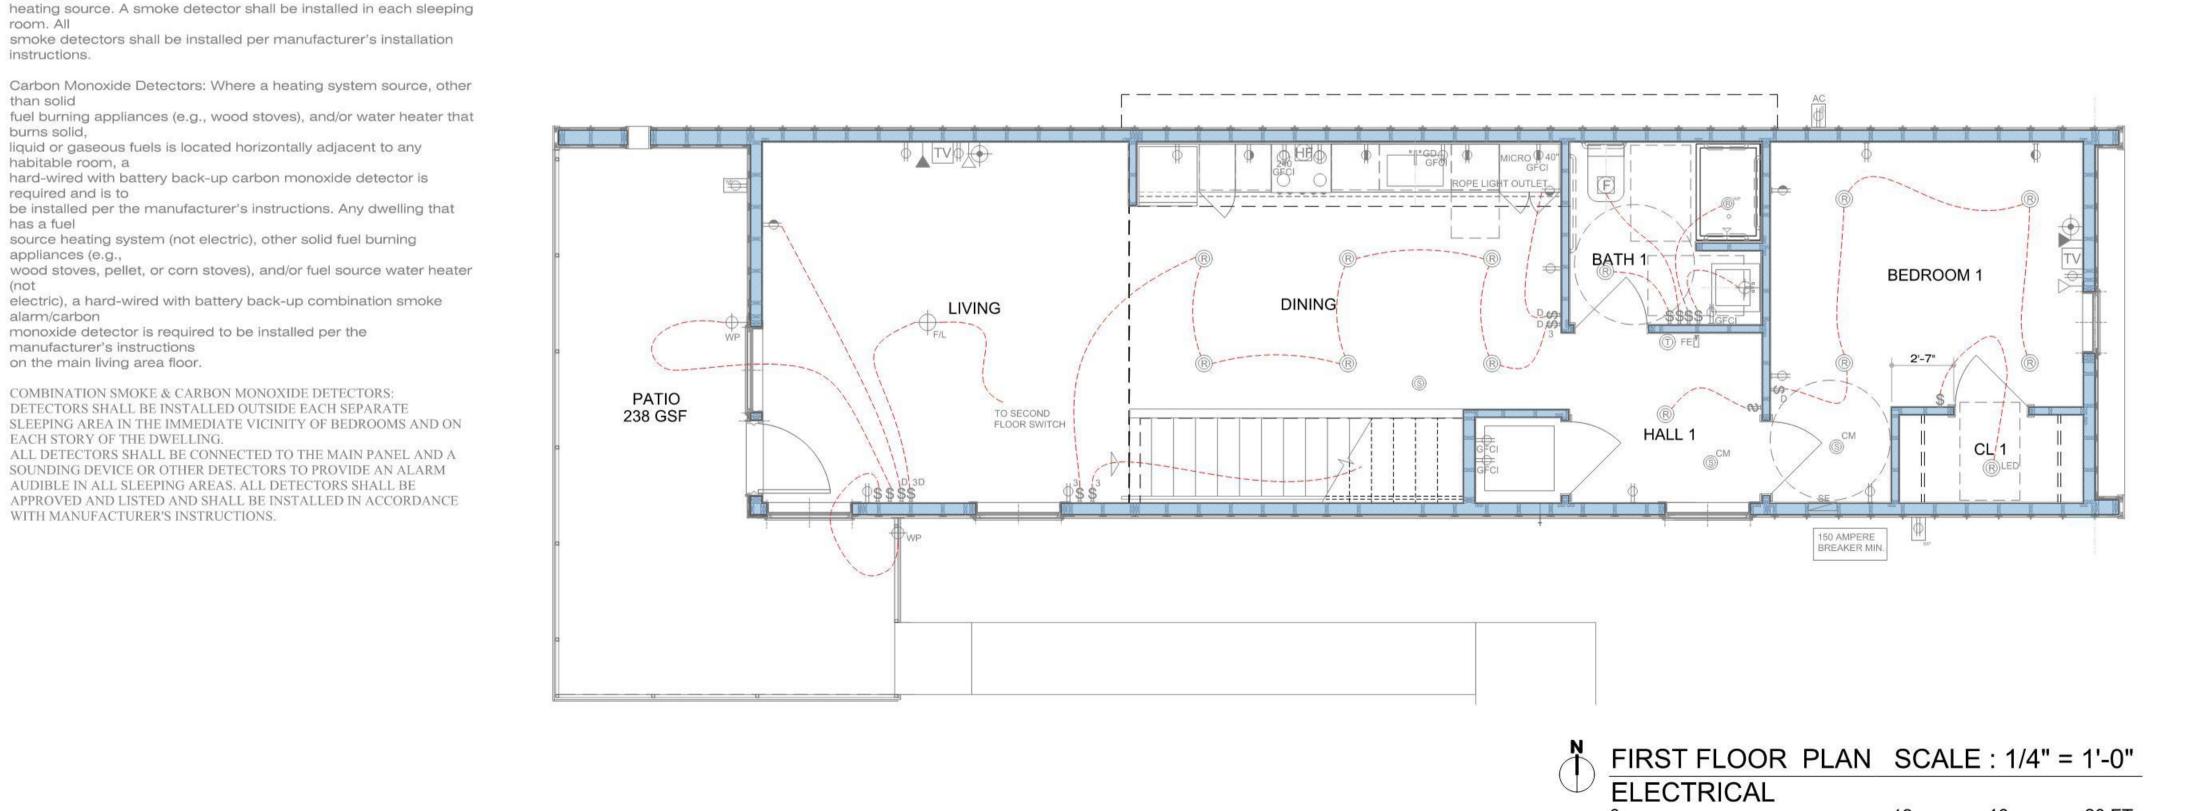



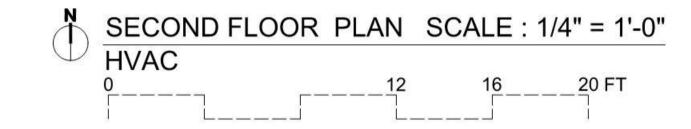

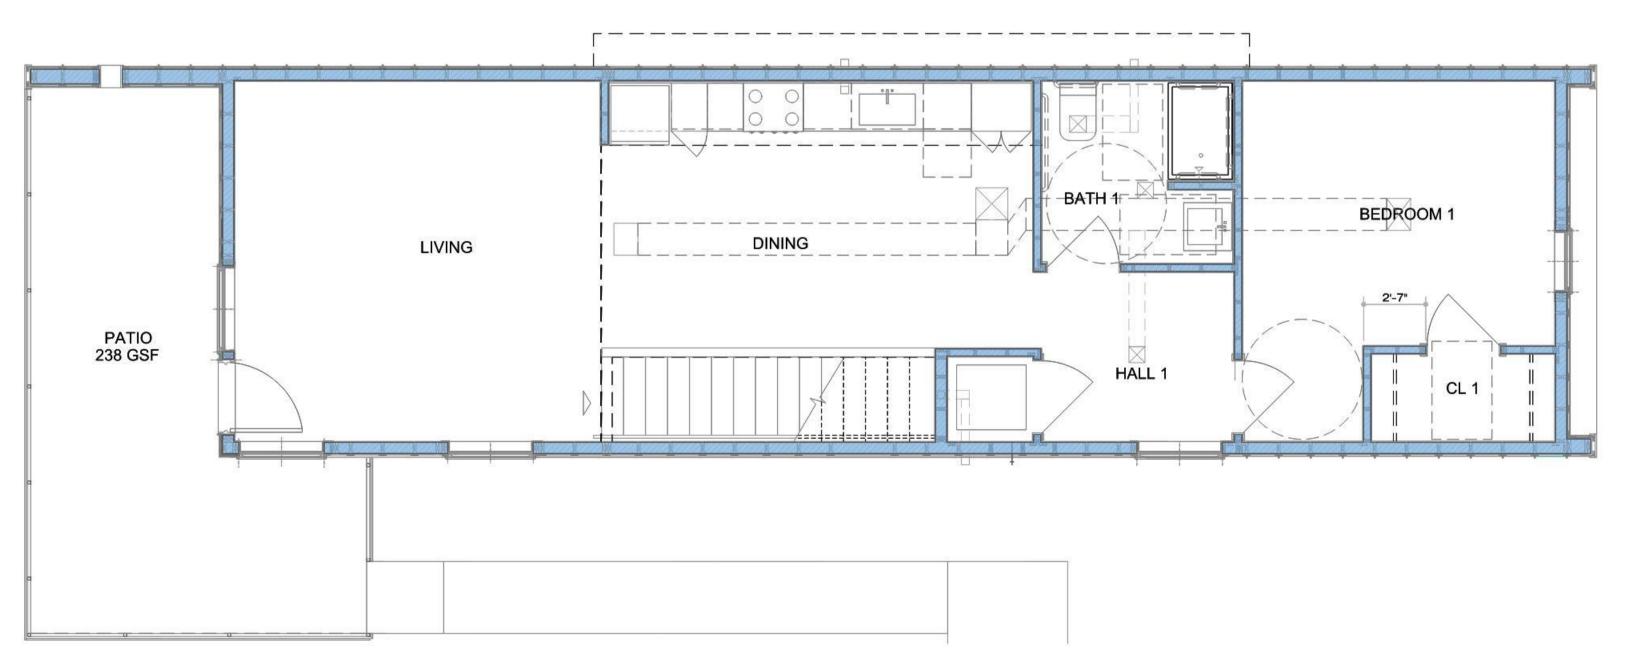

1. DO NOT SCALE FROM THESE DRAWINGS, DIMENSIONS SHALL BE TAKEN FROM ARCHITECTURAL DRAWINGS.

2. THESE DRAWINGS ARE DIAGRAMMATIC AND ARE INTENDED ONLY TO DEFINE THE BASIC FUNCTIONS REQUIRED. ACCESSORIES REQUIRED FOR PROPER OPERATION OF THE SYSTEMS, EVEN THOUGH NOT SPECIFICALLY INDICATED, SHALL BE INCLUDED AND INSTALLED. SUCH ACCESSORIES MAY INCLUDE.

3. SCOPE OF WORK CONSISTS OF FURNISHING LABOR, MATERIALS AND EQUIPMENT FOR THE INSTALLATION. IT ALSO INCLUDES PLACING INTO OPERATION COMPLETE AND OPERABLE HEATING, VENTILATING AND AIR CONDITIONING SYSTEMS AS SPECIFIED AND SHOWN. THIS INCLUDES. BUT IS NOT LIMITED TO: HVAC UNITS, EXHAUST FANS, DUCTLESS SPLIT-SYSTEMS, DUCTWORK, AIR DISTRIBUTION, CONTROLS AND ACCESSORIES.

4. ALL REQUIRED OFFSETS, RISES AND DROPS DUE TO POSSIBLE OBSTRUCTIONS OF DUCT AND PIPE RUNS ARE NOT NECESSARILY SHOWN, MECHANICAL CONTRACTOR SHALL INCLUDE A CONTINGENCY IN HIS BID TO OFFSET ANY COST REQUIRED FOR ADDITIONAL FITTINGS AND LABOR THAT MAY BE REQUIRED.MINOR DEVIATIONS FROM THE DESIGN LAYOUT IN ROUTING OF DUCT AND/OR PIPING ARE ANTICIPATED AND SHALL BE CONSIDERED A PART OF THE WORK INCLUDED. THE CONTRACTOR SHALL VERIFY THE ACTUAL DIMENSIONS OF THE EQUIPMENT PROPOSED TO ENSURE THAT THE EQUIPMENT WILL FIT IN THE AVAILABLE SPACE.

5. HVAC LAYOUT IS BASED ON ARCHITECTURAL DRAWINGS AVAILABLE AT TIME OF DESIGN, AS STRUCTURAL OR OTHER FIELD CHANGES MAY OCCUR, CONTRACTOR IS RESPONSIBLE TO FIELD VERIFY LOCATION OF ALL HVAC EQUIPMENT AND DUCTWORK BEFORE INSTALLATION. MECHANICAL CONTRACTOR SHALL NOTIFY BUILDER OF ANY REQUIRED ALTERATIONS.

6. ALL WORK SHALL BE INSTALLED IN ACCORDANCE WITH THE REQUIREMENTS OF ALL APPLICABLE CODES AND REGULATIONS INCLUDING BUT NOT LIMITED TO NATIONAL, CITY, STATE AND LOCAL ORDINANCES WHICH MAY BE IN EFFECT. ALL HVAC MATERIALS, INSTALLATION PROCEDURES AND SYSTEM LAYOUTS SHALL BE APPROVED BY ALL APPLICABLE CODE ENFORCEMENT AUTHORITIES HAVING JURISDICTION. THE MECHANICAL CONTRACTOR SHALL PROVIDE ALL MATERIALS AND LABOR NECESSARY TO COMPLY WITH THESE RULES, REGULATIONS AND ORDINANCES AT NO ADDITIONAL COST. THESE CODES REPRESENT THE MINIMUM ACCEPTABLE REQUIREMENTS.

7. IT IS THE RESPONSIBILITY OF THE MECHANICAL CONTRACTOR TO PAY FOR ALL NECESSARY PERMITS AND APPROVALS FOR THIS INSTALLATION.

8. IT IS THE RESPONSIBILITY OF THE MECHANICAL CONTRACTOR TO REVIEW THESE PLANS AND SPECIFICATIONS, AS WELL AS THE RELATED HVAC, FIRE PROTECTION, ELECTRICAL, STRUCTURAL, ARCHITECTURAL, INTERIOR DECOR AND SITE ENGINEERING DRAWINGS TO BECOME FAMILIAR WITH THE FULL PROJECT SCOPE. IN ADDITION, THE MECHANICAL CONTRACTOR MUST COORDINATE WITH AN OWNER REPRESENTATIVE TO FULLY UNDERSTAND ALL REQUIREMENTS WHICH MAY NOT BE SPECIFIED HEREIN AND WHICH THE OWNER MAY CONSIDER PART OF THIS CONTRACT. DURING THE COURSE OF CONSTRUCTION COORDINATION AND ACTUAL CONSTRUCTION, IT IS THE RESPONSIBILITY OF THE MECHANICAL CONTRACTOR TO WORK CLOSELY WITH ALL ACCOMPANYING CONTRACTORS AND TRADESMEN IN ORDER TO ENSURE A SMOOTH RUNNING AND CAREFULLY COORDINATED INSTALLATION.

9. ANY DISCREPANCIES OR INADEQUACIES WITHIN THESE BID DOCUMENTS OR BETWEEN THESE BID DOCUMENTS AND THE RELATED PLUMBING, ELECTRICAL, STRUCTURAL, ARCHITECTURAL, AND SITE ENGINEERING DRAWINGS, OR BETWEEN THESE BID DOCUMENTS AND FIELD CONDITIONS MUST BE BROUGHT TO THE ATTENTION OF THE OWNER, ARCHITECT PRIOR TO BID SUBMISSION.

10. THE MECHANICAL CONTRACTOR SHALL FURNISH AND INSTALL NEW PRODUCTS OF ESTABLISHED AND REPUTABLE MANUFACTURERS. NO EQUIPMENT SUBSTITUTIONS SHALL BE MADE THAT WOULD LEAVE INADEQUATE OPERATING OR SERVICE SPACE. EQUIPMENT SHALL BE INSTALLED IN ACCORDANCE WITH MANUFACTURER'S RECOMMENDED INSTALLATION PROCEDURES AND IN AN ARRANGEMENT THAT WILL GIVE THE GREATEST PRACTICAL EASE OF OPERATION AND SERVICE TO THE OWNER.

11. CONSTRUCT AND BRACE EQUIPMENT, PIPING, ETC., SO THAT THERE WILL BE NO VIBRATION AND/OR RATTLING WHEN THE SYSTEM IS IN OPERATION.

12. SPECIFIC REFERENCE TO A MANUFACTURER'S PRODUCT IS ONLY TO ESTABLISH TYPE. QUALITY, AND PERFORMANCE REQUIRED. THESE QUALIFICATIONS ARE IN ADDITION TO THE REQUIREMENTS SHOWN ON THE PLANS.

13. ALL OUTSIDE AIR INTAKES SHALL BE LOCATED A MINIMUM OF 10 FROM ANY PLUMBING VENT, EXHAUST, AND FLUE OUTLETS.

14. EXHAUST DUCTS SHALL TERMINATE THREE (3) FEET FROM ANY BUILDING OPENING AND BE EQUIPPED WITH A BACKDRAFT DAMPER. SCREENS SHALL NOT BE INSTALLED AT THE DUCT

15, ALLOW 24" TO 36" OF STRAIGHT RUN FROM FAN OUTLET POINT BEFORE ADDING AN ELBOW OR BEND TO EXHAUST DUCTWORK.

16. FLASH AND COUNTER FLASH ALL ROOF PENETRATIONS. COORDINATE INSTALLATION OF

ALL ROOF FLASHING AT ROOF PENETRATION. 17. SEAL ALL REFRIGERATION LINE PENETRATIONS AIR AND WATER TIGHT W/ SILICONE

18. MECHANICAL CONTRACTOR SHALL BE RESPONSIBLE FOR TESTING, ADJUSTING, AND BALANCING.

19. CONTRACTOR SHALL INSPECT ANY EXISTING DUCTWORK FOR DEFECTS AND REPORT TO THE ARCHITECT/ENGINEER AND THE OWNER ANY DEFICIENCIES PRIOR TO PERFORMING ANY WORK. CONTRACTOR SHALL CLEAN ALL EXISTING DUCTWORK, GRILLES, REGISTERS AND

20. CONTRACTOR SHALL PAINT BLACK BEHIND ALL GRILLES AND REGISTERS AND INSIDE OF DUCT WHERE VISIBLE.

21. ALL DUCT JOINTS TO BE SEALED IN ACCORDANCE WITH CODE STANDARDS AND ACCEPTED GOOD PRACTICE.

DIFFUSERS PRIOR TO INSTALLING THE NEW WORK.

COMPRESSOR.

22. IF NEEDED CONTRACTOR SHALL PROVIDE AND INSTALL REFRIGERANT PIPING IN ACCORDANCE WITH THE MANUFACTURER'S RECOMMENDATIONS.

23. REFRIGERANT PIPING SHALL BE INSTALLED IN ACCORDANCE IRC CODE STANDARDS.

24. ALL MATERIALS OF INSULATION SHALL BE OF THE TYPE AND QUALITY AS MANUFACTURED BY ARMSTRONG, CERTAINTEED, OWENS-CORNING OR MANVILLE. ALL MATERIAL AND EQUIPMENT SPECIFIED TO BE INSULATED SHALL BE THOROUGHLY TESTED AND APPROVED PRIOR TO APPLYING THE INSULATION. THE INSTALLATION OF ALL INSULATION SHALL BE PERFORMED BY AN EXPERIENCED CRAFTSMAN IN A NEAT WORKMANSHIP-LIKE MANNER AND SHALL BE IN ACCORDANCE WITH THE MANUFACTURER'S WRITTEN RECOMMENDATIONS FOR SERVICE INTENDED.

25. VIBRATION ISOLATORS FOR AC EQUIPMENT SHALL BE EQUAL TO MASON INDUSTRIES MODEL 30N, COMBINATION SPRING AND DOUBLE DEFLECTION NEOPRENE HANGER, OR DEFLECTION AS RECOMMENDED BY MANUFACTURER.

26. CONTRACTOR SHALL VISIT THE SITE AND VERIFY ALL DIMENSIONS IN THE FIELD, AND SHALL ADVISE THE ARCHITECT/ENGINEER AND THE OWNER OF ANY DISCREPANCIES BEFORE PERFORMING THE WORK.

27. THE CONTRACTOR SHALL PROVIDE MAINTENANCE INSTRUCTIONS FOR EQUIPMENT AND SYSTEM THAT REQUIRE PREVENTATIVE MAINTENANCE. INSTRUCTIONS SHALL BE CLEARLY STATED AND INCORPORATED ON A READILY ACCESSIBLE LABEL AND INCLUDE THE TITLE OR PUBLICATION NUMBER FOR THE OPERATION AND MAINTENANCE MANUAL FOR THAT PARTICULAR MODEL AND TYPE OF PRODUCT.

### NICOLAS CASCARANO

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#### REVISION:

SET DATED:11.20.2021 SET DATED :09.27.2021 SET DATED:08.23.2021 SET DATED: 04.04.2021 SET DATED:03.15.2021

PROJECT NAME:

### **4X4 ALL TERRAIN** SINGLE FAMILY RESIDENCE

PROJECT LOCATION: 4600 ROBERTSON STREET Houston, Texas 77009

OWNER:

CITY OF HOUSTON HOUSING AND COMMUNITY DEVELOPMENT DEPT. 2100 TRAVIS STREET | 9TH FLOOR | HOUSTON TX 77002








A HOUSING AND URBAN

4X4 ALL TERRAIN

DRAWING NAME: **FLOOR PLANS HVAC LAYOUT** 


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SHEET

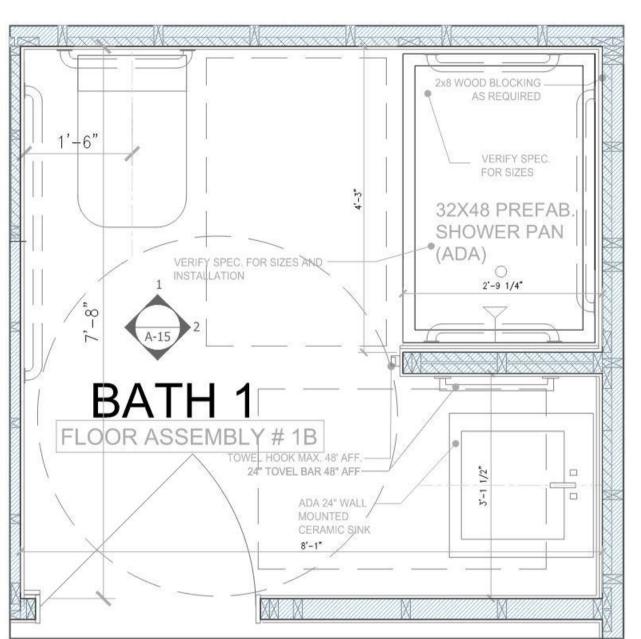

**FLOOR PLAN** BATH 1

SCALE: 3/4" = 1'-0"

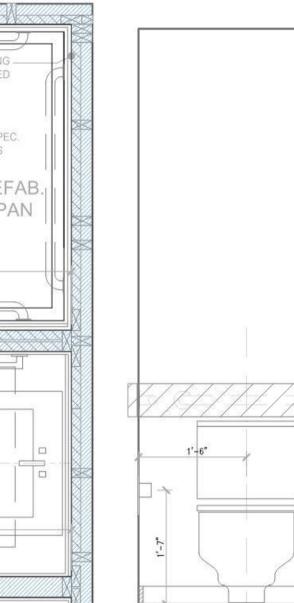

(GFC) ELECTRICAL

OUTLETS AS REQUIRED)

1. TOILET / SHOWER

SOLID WOOD BLOCKING FOR GRAB

BARS AND ACCESSORIES

#### TILE OVER APPROVED TILE BACKER BOARD - CURTAIN ROD WP LIGHT FIXTURE MCKINSEY 1-LIGHT LED - DWB (PAINTED GREEN BATH BAR BOARD) - SHOWER HEAD (GFCI ELECTRICAL OUTLETS AS REQUIRED) MEDICINE CABINET - 24-7/16"W - FUTURE 18" HT. X 32-7/16"H X 5"D VERTICAL GRAB BAR VERIFY SPEC. - TOWEL HOOK MAX. 48' AFF. TOWEL HOOK FOR SIZES TOWEL BAR MAX. 48AFF. - ADA 24" WALL MOUNTED - TILE SOAP DISH MAX. 48' AFF. ----CERAMIC SINK TILE ON - 2x8 WOOD BLOCKING APPROVED TILE AS REQUIRED BACKER BOARD - ADA SHOWER CONTROLS 2x8 WOOD BLOCKING AS REQUIRED - FUTURE 24" GRAB BAR - TILE OVER APPROVED TILE BACKER BOARD - PRE-FAB. 1 -6 7/8" SHOWER PAN SEALANT 2. SHOWER / VANITY (GFCI ELECTRICAL OUTLETS AS REQUIRED)

ADA 24" WALL MOUNTED

ADA VANITY SPEC. OPTION: CERAMIC SINK CERAMIC WALL MOUNT INSTALLATION

DELTA VERO SINGLE HOLE BATHROOM FAUCET WITH POP-UP DRAIN ASSEMBLY - INCLUDES LIFETIME WARRANTY MODEL: 553LF

MODEL: 77724 Glacier Bay (TOILET) 1-Piece 1.1 GPF/1.6 GPF High Efficiency Dual Flush Elongated All-in-One Toilet in White

OLENE 24" SINGLE BATHROOM VANITY SET WITH MIRROR SKU: W002312681 MEDICINE CABINET -24-7/16"W X 32-7/16"H

MODEL: 553LF

ADA - BATH # 1

62 1/2" X 32 1/2" ADA SHOWER PAN ACRYLIC (60" X 30" ID) MODEL: APA6232BFPAN

FUNCTION PRESSURE BALANCED SHOWER WITH OVERFLOW SYSTEM WITH INTEGRATED VOLUME CONTROL, SHOWER HEAD, AND HAND SHOWER - INCLUDES ROUGH-IN VALVES MODEL:DSS-VERO-1701 DELTA VERO DOUBLE ROBE HOOK


MODEL: 77736 DELTA VERO 24" TOWEL BAR DELTA VERO SINGLE HOOK TISSUE HOLDER MODEL: 77750

DELTA VERO SINGLE HOLE VANITY FAUCET WITH POP-UP DRAIN ASSEMBLY - INCLUDES LIFETIME

48X30 PREFAB. SHOWER PAN VERIFY SPEC. FOR SIZES 1'-6 3/4" HOOK 60" AFF 24" TOVEL BAR - 60" AFF \_ 2x8 WOOD BLOCKING AS REQUIRED FLOOR ASSEMBLY4 2B BATH 2 24" TOVEL BAR ----60" AFF 2x8 WOOD BLOCKING 2"-0" AS REQUIRED \_ VERIFY SPEC. FOR SIZES AND INSTALLATION

**FLOOR PLAN** BATH 2

SCALE: 3/4" = 1'-0"

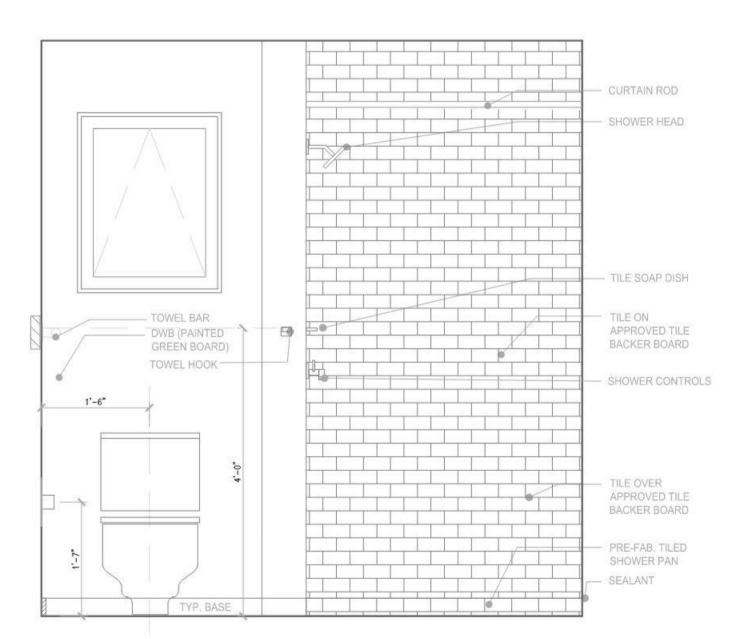


(GFCI ELECTRICAL

3. TOILET / SHOWER

BATH # 2 REDI BASE® SINGLE CURB SHOWER PAN WITH CENTER OLENE 24" SINGLE BATHROOM VANITY SET WITH MIRROR SKU: W002312681 DRAIN, 30"D X 48"W Shower Base with Single P3048C-PVC BATH 2 DELTA SHOWER FAUCET VERO 17 SERIES DUAL-FUNCTION SHOWER TRIM KIT WITH SINGLE-SPRAY MEDICINE CABINET -TOUCH-CLEAN RAIN SHOWER HEAD, CHROME T17253 24-7/16"W X 32-7/16"H DELTA VERO DOUBLE ROBE HOOK DELTA VERO SINGLE HOLE VANITY FAUCET WITH MODEL: 77736 POP-UP DRAIN ASSEMBLY - INCLUDES LIFETIME WARRANTY DELTA VERO 24" TOWEL BAR MODEL: 553LF MODEL: 77724 Glacier Bay (TOILET) DELTA VERO SINGLE HOOK TISSUE 1-Piece 1.1 GPF/1.6 GPF High Efficiency Dual Flush HOLDER Elongated All-in-One Toilet in White MODEL: 77750

APPROVED TILE BACKER BOARD WP LIGHT FIXTURE MCKINSEY 1-LIGHT LED . BATH BAR DWB (PAINTED GREEN BOARD) - MEDICINE CABINET -24-7/16"W X 32-7/16"H X 5"D (GFCI ELECTRICAL OUTLETS AS REQUIRED) VERIFY SPEC. FOR SIZES - ADA 24" WALL MOUNTED CERAMIC SINK - 2x8 WOOD BLOCKING AS REQUIRED 21-0

4. VANITY

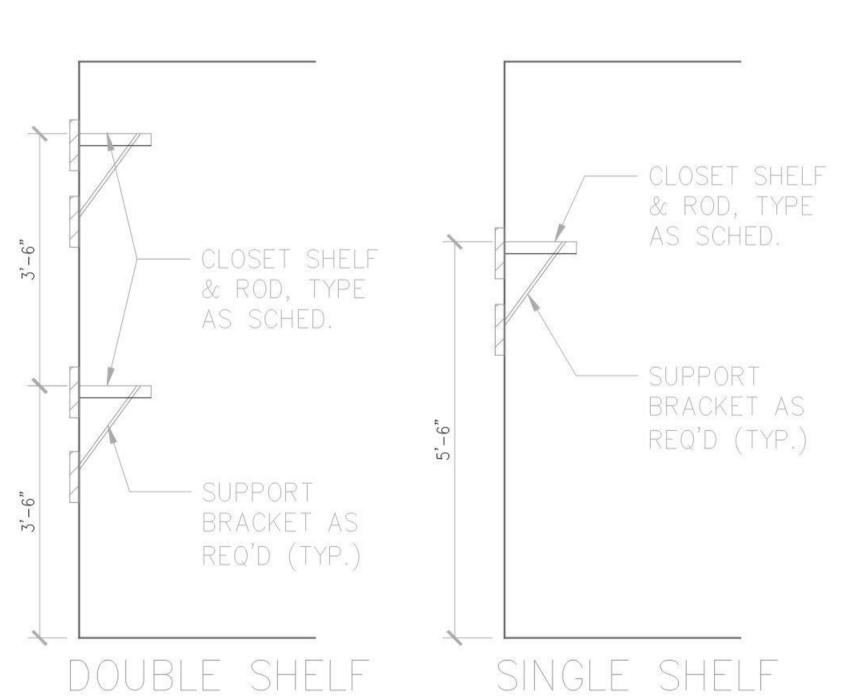

GENERAL NOTES:

1. INSTALL SHELF AND ROD PER MANUFACTURER'S SPECIFICATIONS, PROVIDE SOLID WOOD BLOCKING AS REQUIRED.

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REVISION:

SET DATED:11.20.2021 SET DATED :08.23.2021 SET DATED:04.04.2021 SET DATED:03.15.2021

PROJECT NAME:

**4X4 ALL TERRAIN** SINGLE FAMILY RESIDENCE

PROJECT LOCATION: 4600 ROBERTSON STREET Houston, Texas 77009

OWNER: CITY OF HOUSTON HOUSING AND COMMUNITY DEVELOPMENT DEPT 2100 TRAVIS STREET | 9TH FLOOR | HOUSTON TX 77002











4X4 ALL TERRAIN


DRAWING NAME:

**BATH 1& 2** 

A-15 SHEET

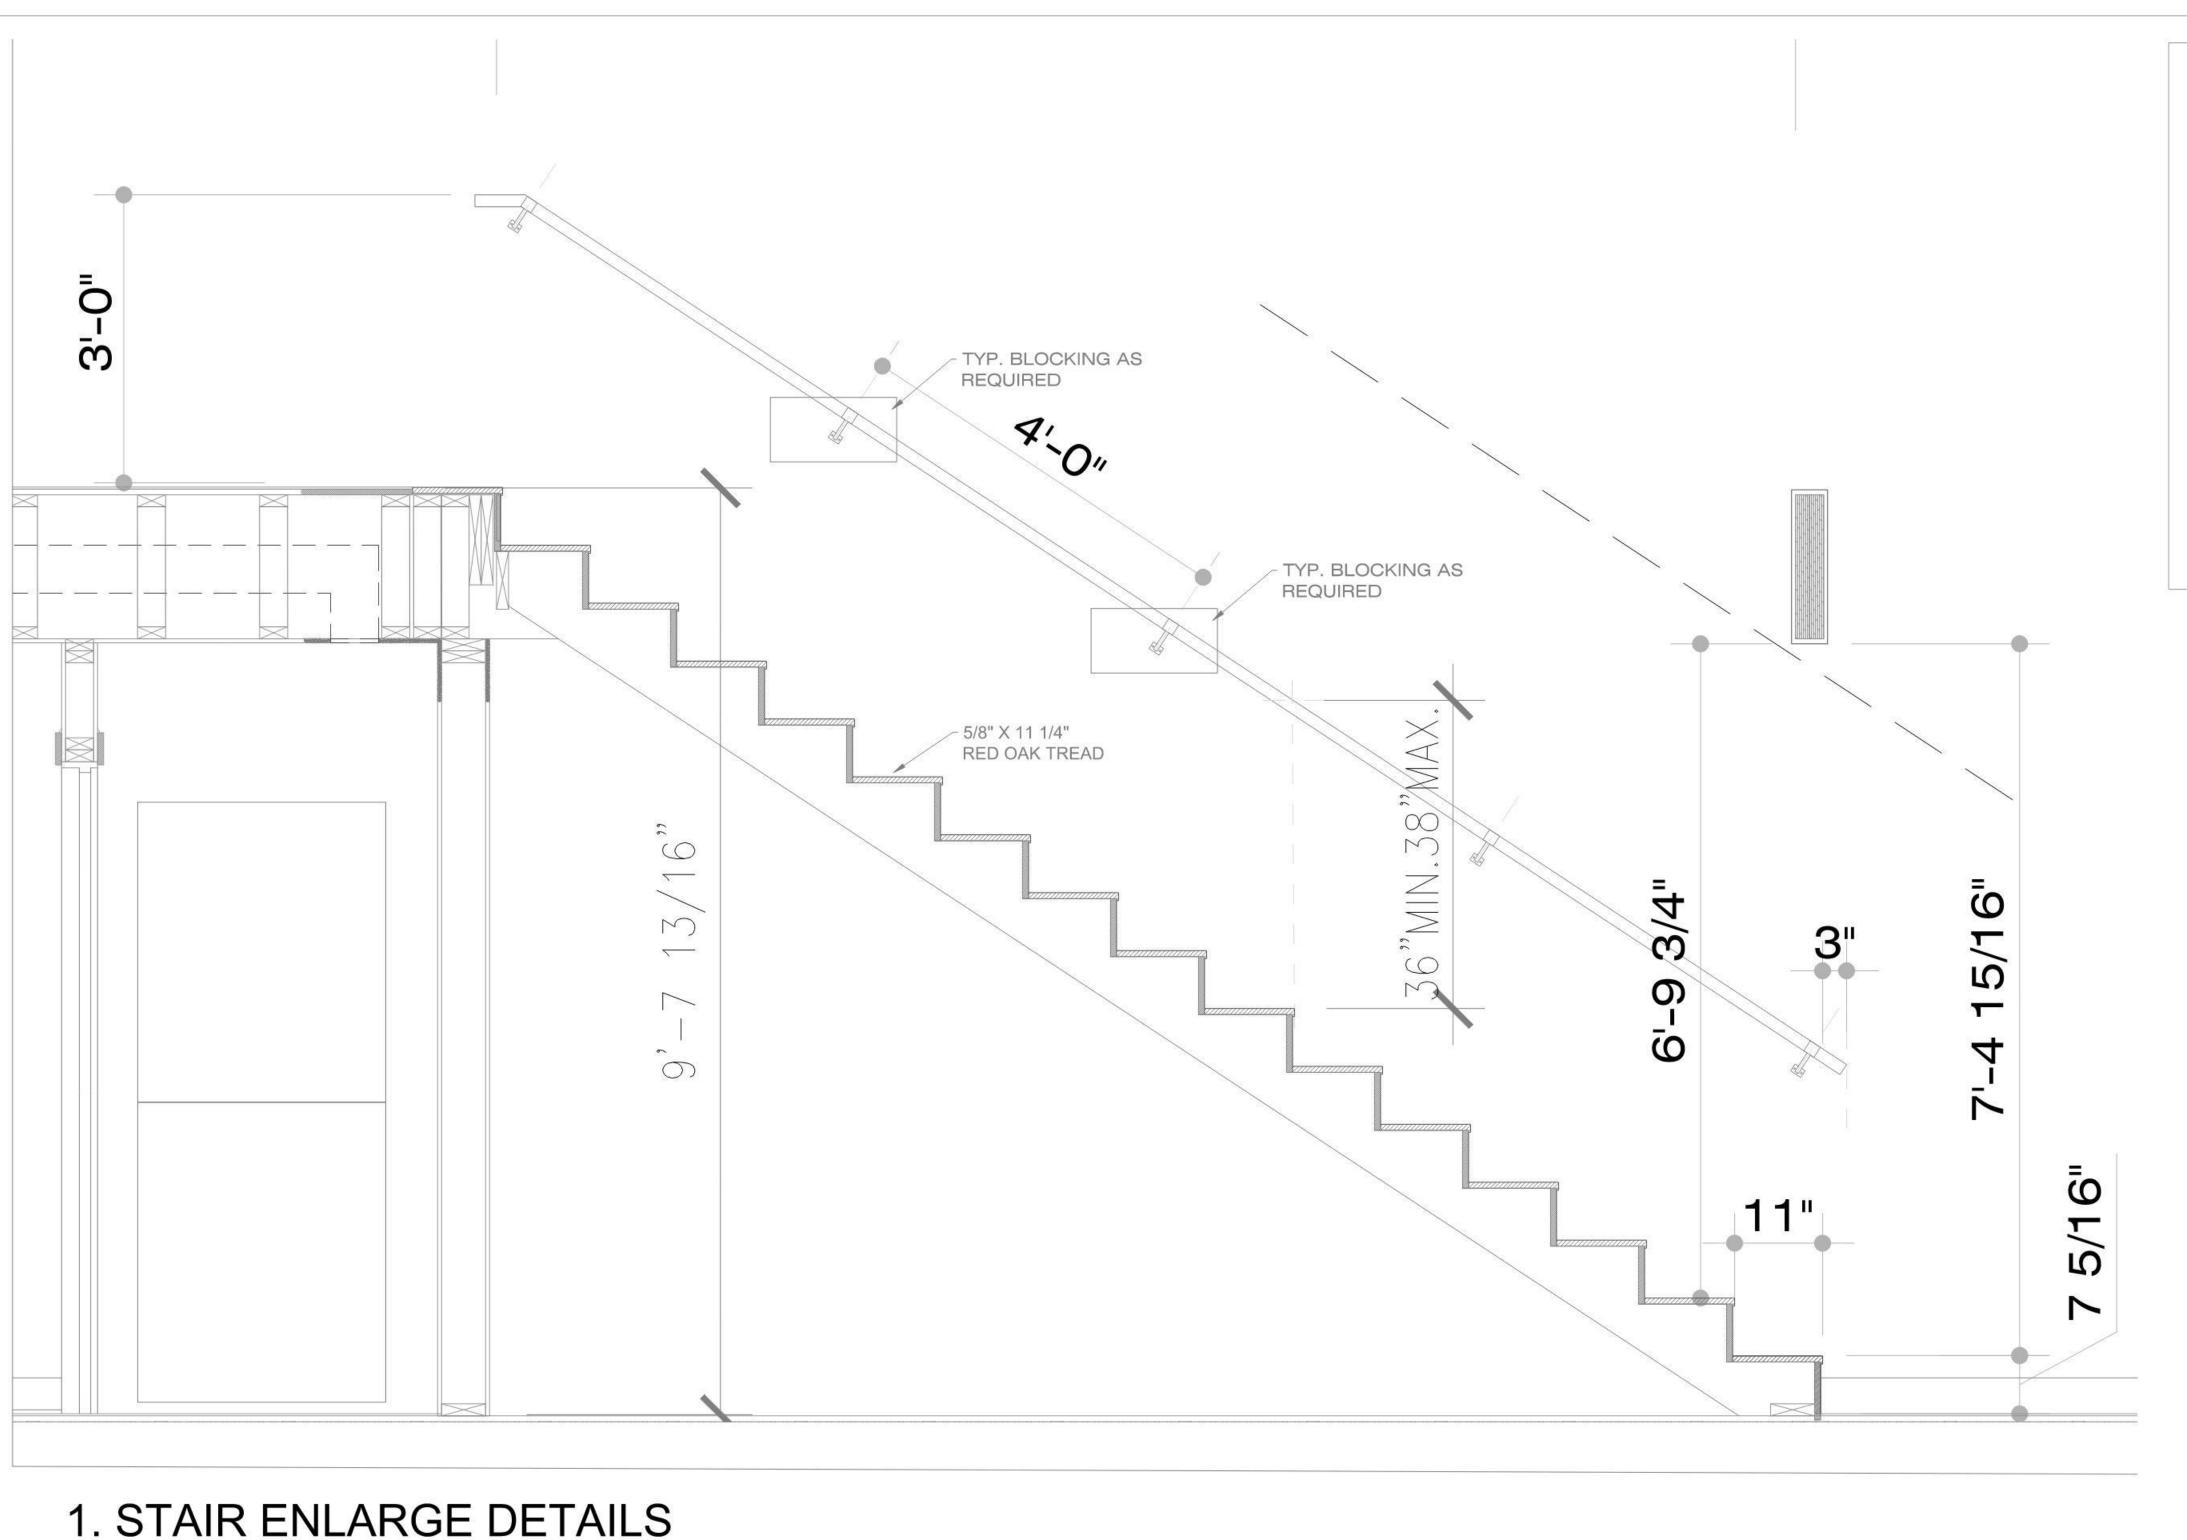

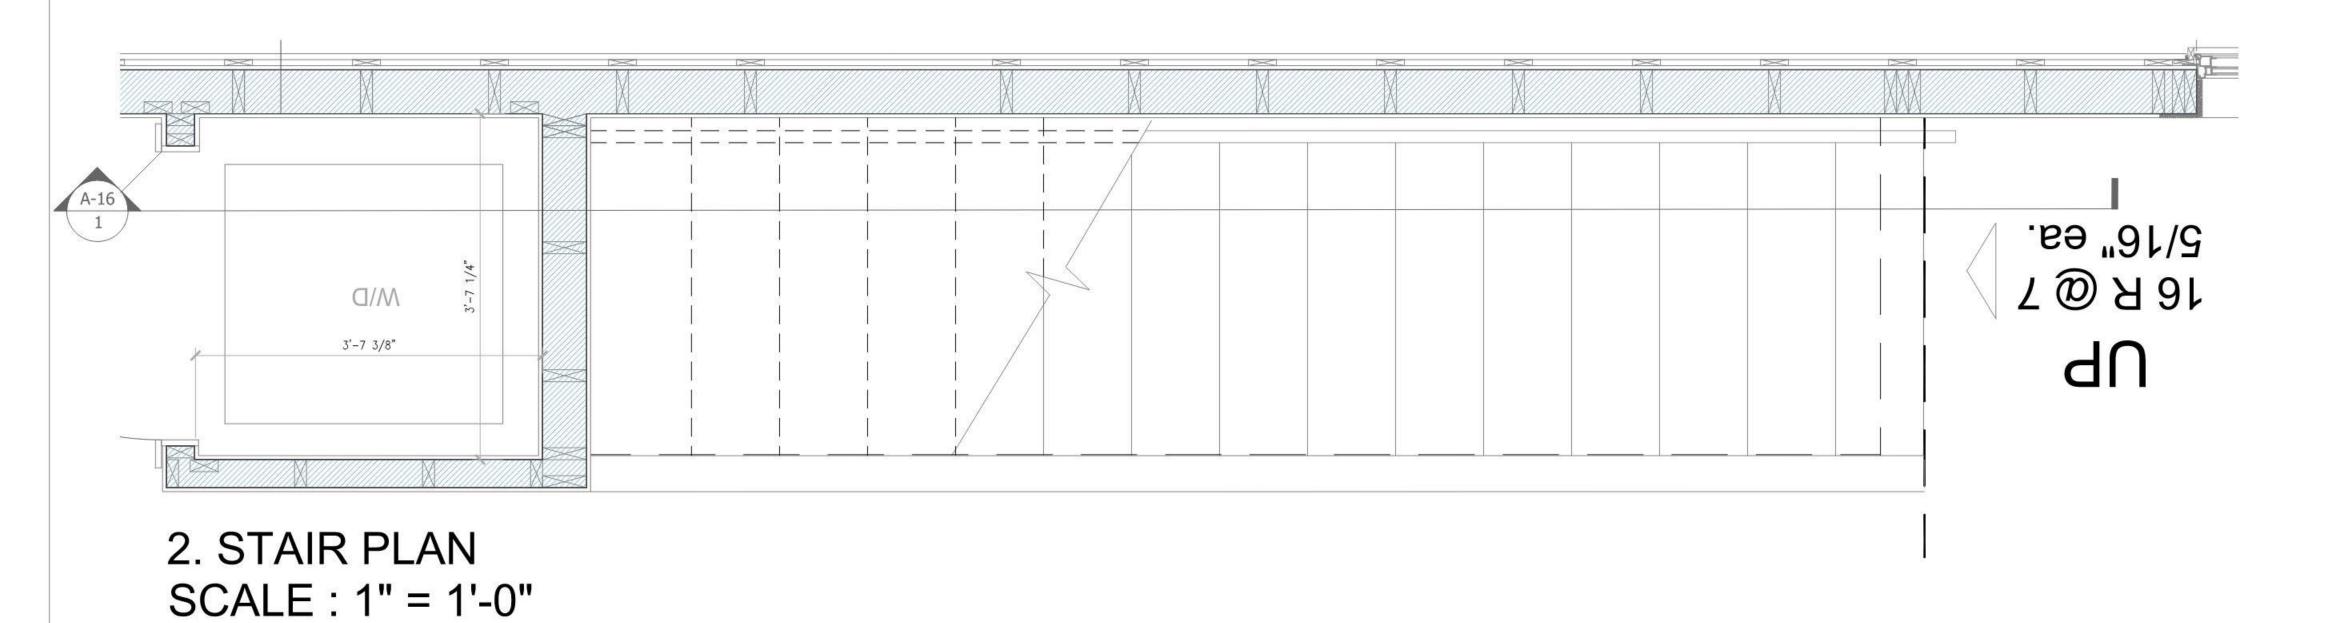

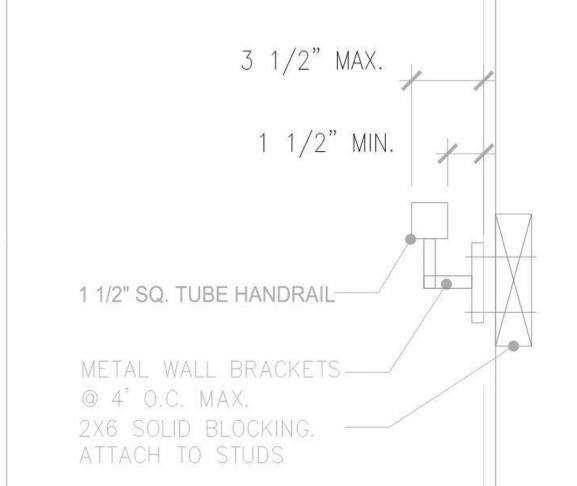

ARCHITECT, AIA 14520 Briar Forrest Drive #2308 Houston, Texas 77077 ARQUITECTURA3000@ATT.NET



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### REVISION:

SET DATED: 11.20.2021
SET DATED: 09.27.2021
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SET DATED: 06.06.2021
SET DATED: 04.04.2021
VALUE ENGINEERED SET
SET DATED: 03.15.2021

### PROJECT NAME:

# **4X4 ALL TERRAIN**SINGLE FAMILY RESIDENCE

PROJECT LOCATION: 4600 ROBERTSON STREET Houston, Texas 77009

### OWNER:

CITY OF HOUSTON HOUSING AND COMMUNITY DEVELOPMENT DEPT. 2100 TRAVIS STREET | 9TH FLOOR | HOUSTON TX 77002










4X4 ALL TERRAIN

DRAWING NAME:

STAIRS DETAILS

A-16


SHEET

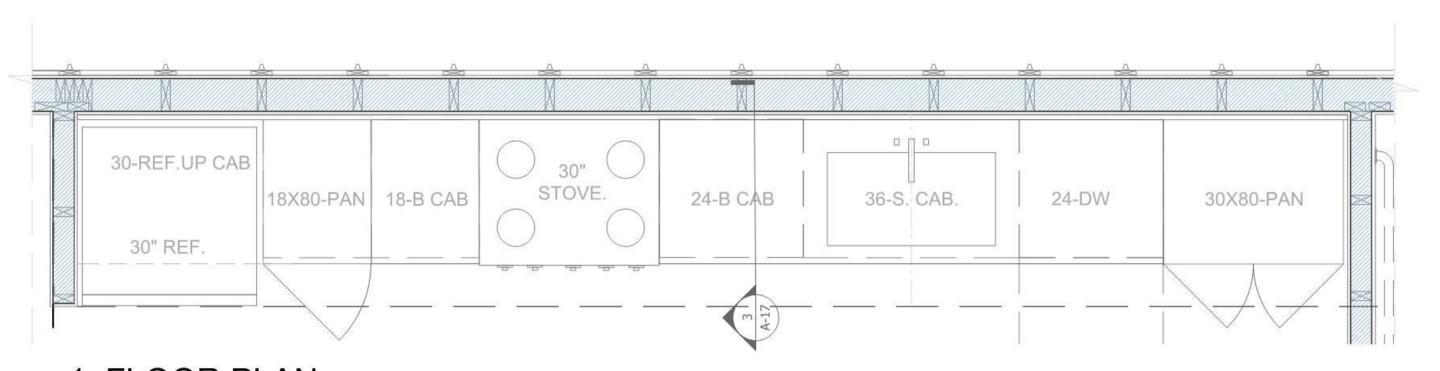

1. FLOOR PLAN KITCHEN

SCALE: 3/4" = 1'-0"



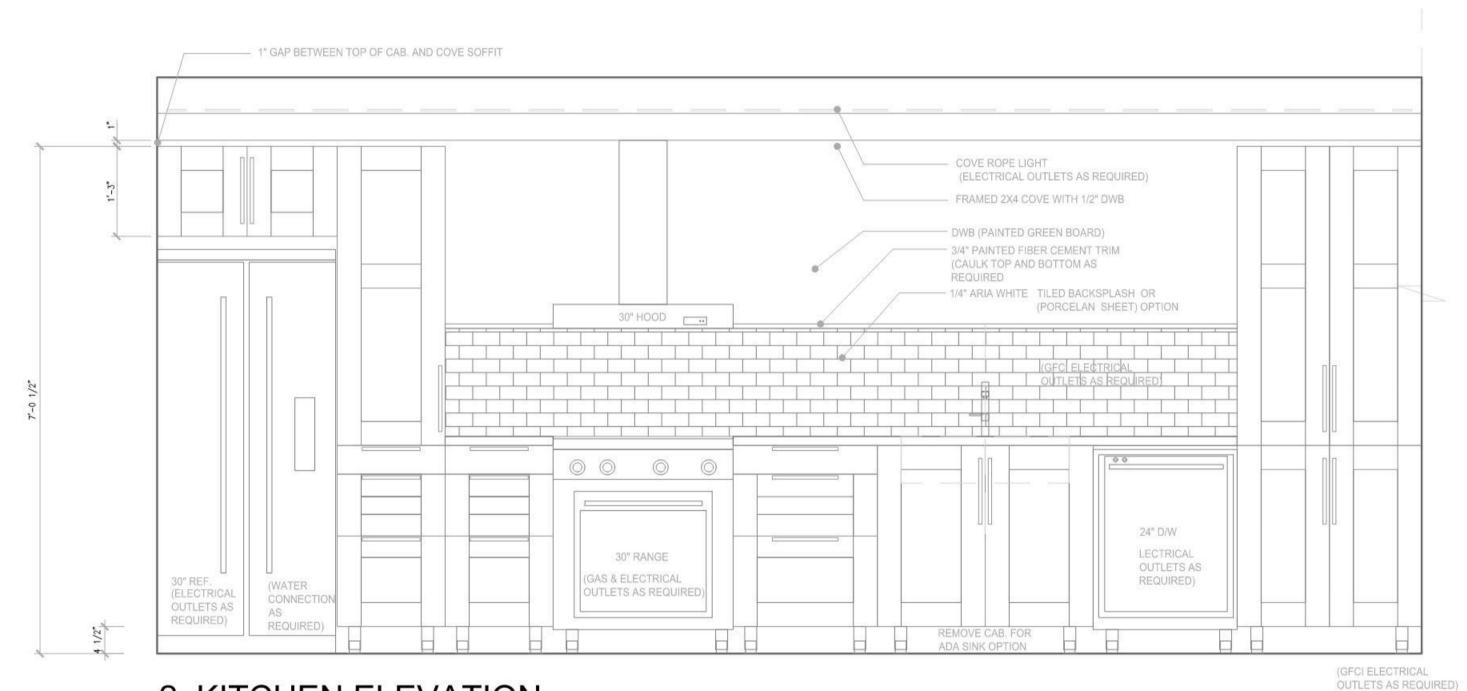

2. KITCHEN ELEVATION

FAUSET & SINK SPEC. KRAUS FAUSET KPF-1610SS Bolden Single Handle 18-Inch Commercial Kitchen Faucet with Dual Function Pull Down Spray Head Finish Kpf-1610SS, Stainless Steel KRAUS SINK Standart PRO 30in. 16 Gauge Undermount Single Bowl Stainless Steel Kitchen Sink EXHAUST CEILING FAN PANASONIC FV-0511VKS2 WHISPERGREEN MULTI-FLOW BATHROOM FAN, WHITE

VENT HOOD SPEC., RANGE ZLINE RANGE Professional 30 in. 4.6 cu. ft. 6-Gas Burner/Electric Oven Range in Stainless ZLINE HOOD ZLINE 30 in. 760 CFM Wall Mount Range Hood in Stainless Steel

CABINETS SPEC. CABINETS SPEC. OPTION CABINETS (IKEA) HILLESJÖN DOUBLE BOWL DUAL MOUNT SINK STAINLESS STEEL29 1/2X18 1/8" 50341643 ÄLMAREN KITCHEN FAUCET STAINLESS STEEL CABINETS NOB: 12 " BILLSBRO HANDLE STAINLESS STEEL CABINETS LEGS SEKTION LEG ADJUSTABLE 4 1/2 " DISHWASHER SPEC.

3. SECTION

1'-0"

WASHER / DRYER SPEC. Whirlpool 3.5 Cu. Ft. White Electric Stacked Laundry Center - WET4027HW RECESSED DRYER VENT Dundas Jafine DRB4XZW Box, 4", White WATER OUTLET BOX Hydro Master Washing Machine, Washing Stop Valves with Water Hammer Arrestor

COVE ROPE LIGHT

- 2x8 WOOD BLOCKING

AS REQUIRED

REQUIRED

SHEET) OPTION

COUNTERTOP OAK/VENEER

(ELECTRICAL OUTLETS AS REQUIRED)


FRAMED 2X4 COVE WITH 1/2" DWB

3/4" PAINTED FIBER CEMENT TRIM


TILED BACKSPLASH OR (PORCELAN

(CAULK TOP AND BOTTOM AS


DWB (PAINTED GREEN BOARD)

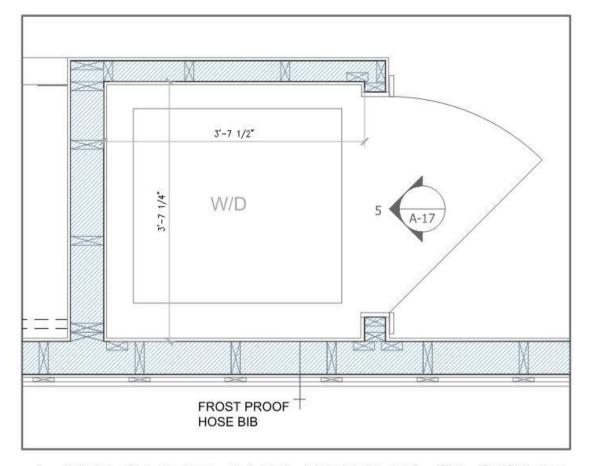

4. WASHER AND DRYER CLOSET SCALE: 3/4" = 1'-0"

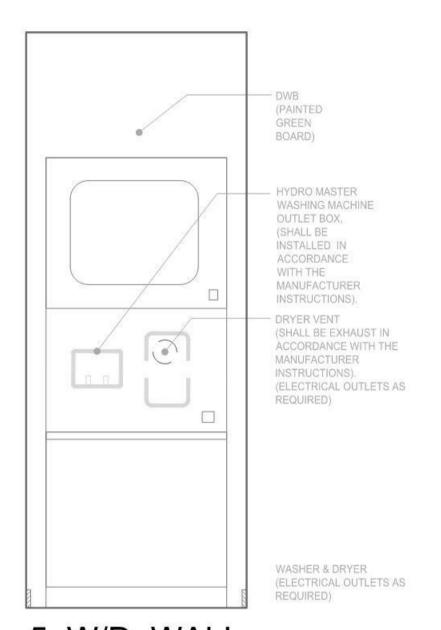

5. W/D WALL

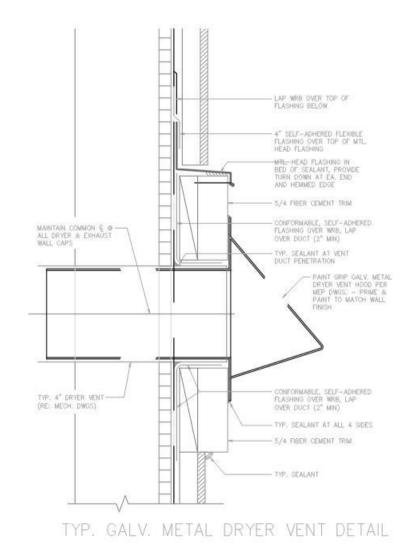

NICOLAS CASCARANO

ARCHITECT, AIA 14520 Briar Forrest Drive #2308 Houston, Texas 77077 ARQUITECTURA3000@ATT.NET



100% SET FOR PERMIT

REVISION: SET DATED:11.20.2021

SET DATED:09.27.2021 SET DATED :08.23.2021 SET DATED:04.04.2021 SET DATED:03.15.2021

PROJECT NAME:

**4X4 ALL TERRAIN** SINGLE FAMILY RESIDENCE

PROJECT LOCATION: 4600 ROBERTSON STREET Houston, Texas 77009

OWNER: CITY OF HOUSTON HOUSING AND COMMUNITY DEVELOPMENT DEPT. 2100 TRAVIS STREET | 9TH FLOOR | HOUSTON TX 77002









A HOUSING AND URBAN DESIGN COMPETITION

4X4 ALL TERRAIN

DRAWING NAME: **KITCHEN** 

A-17 SHEET

ROOM NAME		FLO(	)R			WALLS								MILLWORK WALL BASE						CEILING					DOORS			REMARKS		
							N	IATERIAL	FINISH					MATERIAL			FINISH	MATERIA		AL	L			HT.					DOOR	
		SHEET VINYL	RETE	HARDWOOD		TILE	GYPSUM BOARD - 1/2" REG. GYPSUM BOARD - 1/2" M.R.	BOARD - 5/8"					AMS 7631 CITY LOFT	FIBER CEMENT 1X4 MDF BOARD S4S	NONE	MIC TILE	SEMI-GLOSS PAINT MATCH WALL	GYPSUM BOARD - 1/2" REG.	GYPSUM BOARD - 5/8" TYPE "X"	BUARU - 3/0	MATCH WALL LIGHT TEXTURED	PAINT	SEMI-GLOSS PAINT	2 2 3	SHELVING	36X80 (ALL FLUSH DOORS)	CORE (OAK FIN	W CORE (OAK FINISH) STAI	KWIKSET 91550-001 HALIFAX DHANDLE LEVER (SATIN NICKEL)	
LIVING ROOM		X		100000	Meani	-	X			( )	-		X	Χ			X	X	550784 AC		+	X		( 21'-8 7/	_		2 2322	PRO ESPECIAL ()	X	
LAUNDRY CLOSET	41 11 12	X	(			81	Χ		<b>\</b>	( )	(		Х	Χ			X	X			X	X	>	( 8'-0"		X	X	(	Х	
KITCHEN	V 1	X	(				X		<b> </b>	( )	(		Х	Χ			Х	Х			X	X	>	( 8'-0"					X	
HALL 1		X	(				Х			( )	(		Х	Χ			Х	X			X	X	>	( 8'-0"					Х	
BATH 1						X	ХХ		\ \ \ \ \	′		X	Х	Х			X	X			X		X	( 8'-0"		X	X	(	X	
BEDROOM 1		X	(				X		)	( )	(		X	Χ			X	X			X	X	>	( 8'-0"		X	X	(	X	
CLOSET 1		X	(				Χ			\ \	(		Х		X		X	X				Х	>	( 8'-0"	WIR	EX	1.5	X	Х	
HALL 2	X								)	( )	(		Х	Х			Х	X			X		>	( 8'-0"					X	
BATH 2						Χ	ХХ		\ \ \ \ \	( )	(	X	Х	Χ			X	X			X		X	8'-0"		X	X	(80) III	Х	
BEDROOM 2	X					12			>	( )	(		X	Χ			X	X			X		>	( 12'-1 1/8	3"	X	X		Х	
CLOSET 2	X						Χ			>	(		Х		X		X	X				X	>	8'-0"	WIR	E X	NS (1)	X	Х	
BEDROOM 3	X								)	( )	(		X	Χ			X	X			X		>	8'-0"		X	X	(	Х	
CLOSET 3	X						X		)	( )	(		X		Χ		X	X				X	>	8'-0"	WIR	E X		X	Х	
HVAC/WATER HEATER CLOSET						8				)	(		X		X			X		3.		X	>	( 8'-0"		X	X	(	Х	DOOR VENT AS R

TYP.VINYL PLANK: Sterling Oak 8.7 in. W x 47.6 in. L Luxury Vinyl Plank Flooring



ARCHITECT, AIA 14520 Briar Forrest Drive #2308 Houston, Texas 77077 ARQUITECTURA3000@ATT.NET



100% SET FOR PERMIT

#### REVISION:


SET DATED: 11.20.2021
SET DATED: 09.27.2021
SET DATED: 08.23.2021
SET DATED: 06.06.2021
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VALUE ENGINEERED SET
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CITY OF HOUSTON
HOUSING AND COMMUNITY DEVELOPMENT DEPT.
2100 TRAVIS STREET | 9TH FLOOR | HOUSTON TX
77002







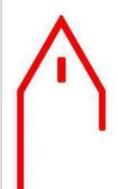

4X4 ALL TERRAIN

INTERIOR FINISH
SCHEDULE

A-18 SHEET

2 4